



REQUEST FOR PROPOSALS (RFP)

FRISCO BAY MARINA BOAT RAMP TURNAROUND DRAINAGE IMPROVEMENTS

Invitation:

The Town of Frisco is seeking proposals, in this RFP, for CONSTRUCTION services for the project named above. All bids associated with this RFP shall be due no later than 12:00PM, Friday, January 27th, 2023.

Background:

In 2019, the Town of Frisco completed the Big Dig and Phase 1 of the Frisco Bay Marina. The project included the construction of a new beach, widening of the pier, new docks and dock system, new boat ramp, and boat ramp turnaround area. The installation of the of the new turnaround area, located at the top of the boat ramp, was designed in a manner that directs all the drainage from storm events and vehicles/trailers that have just launched, away from Dillon Reservoir and into a storm sewer that is 165ft to the west, with an elevation difference of 2ft. The inlet and drainage structure are part of a small storm system that is tied into a cistern that was intended to act as a dry well, which would allow all the sediment to settle in a contained area and let the water percolate into the soil(s).

Several years of operation have passed since its installation, it has been determined that the original design has not worked and there is now a ponding issue stemming from groundwater infiltrating into the cistern at a rate that causes it to surcharge. Due to this, a significant portion of the turnaround area floods where the reservoir level matches the rim elevation of the inlet (9,017.23ft), and when the reservoir is over full, nearly the entire turnaround area will be submerged.

Knowing that a solution needed to be created, the Town of Frisco has been working with its contracted civil engineer, JR Engineering, to find a solution to this problem. After on-site visits and a thorough analysis of data concerning groundwater levels and reservoir water levels, the Town and JR Engineering decided to rework the existing storm system by turning the dry well to a wet well and adding a sump pump to the system. This will ensure that the entire system can be pumped into a detention pond, and the turnaround area can be kept free of major ponding in the future.

Project Scope and Description:

The Town of Frisco is seeking proposals from qualified firms to assist in the completion of a design (currently at 60%), working closely with the Town's contracted engineer (JR Engineering), to produce a 100% CD set of drawings. After completion of the drawings, the contractor would be responsible for constructing the plan as designed. The scope shall include:

- Removal and replacement of hardscape surfaces
- Removal of previous piping and installation of new piping
- Decommissioning of previous cistern drywell area with flowfill
- Electrical connections and conduit installation
- Sump pump installation and all associated apparatuses
- Water quality pond upgrade and expansion
- Storm manholes
- Riprap placement
- Drainage channel
- Reseeding and restoration of impacted area(s)

Project Schedule:

The Town of Frisco would like to see completion of this project by October 2020.

RFP Advertisement	January 4, 2023
Mandatory Site Visit	January 10, 2023 @ 10AM
Questions Due, via email	January 13, 2023 @ 3PM
Questions Answered, via email	January 18, 2023 @ 3PM
RFP Submissions Deadline	January 27, 2023 @ 12PM
Select Firm	January 28, 2023
<i>*Pending Council Approval</i>	
Contract to Council	February 14, 2023

Additional Information:

Additional information concerning this Request for Proposals (RFP) is available from:

Addison Canino
Assistant Public Works Director
Town of Frisco Public Works
AddisonC@townoffrisco.com

Project Contacts:

- Addison Canino, Assistant Director, Frisco Public Works
 - 970.331.6632
 - AddisonC@townoffrisco.com

All Proposals Shall Include:

- Name, address and telephone number of person(s) authorized to legally represent firm.
- Any confidential information in the proposal shall be labeled or marked as *CONFIDENTIAL*.
- Background experience in stormwater system installation or repair
- Proof of insurance coverage that the firm maintains.
 - Town of Frisco will require insurance certificates naming the Town as co-insured.
- Provide project costs for services provided in an itemized format on the provided bid tabulation sheet.

Proposed Fees:

Proposal should include all fees the contractor anticipates based on the plans and information given in this RFP. Fees should be based on, as much as possible, on unit prices where units are noted, or a lump sum where appropriate. Include bonding costs in fee proposal, in addition to any other anticipated design costs.

Proposal Response:

Proposal response shall contain all information as requested herein, and any additional information necessary to summarize the overall benefit of the proposal to the Town. A bid tab will be provided in the solicitation of this RFP, and all prospective bidders shall complete the bid tab with their proposal. Proposing firms should submit their proposal electronically no later than 12:00PM, January 27th, 2023. Late proposals will not be accepted under any circumstance. Since proposals will be sent electronically, all emails shall have the subject line of “FRISCO BAY MARINA BOAT RAMP TURNAROUND DRAINAGE IMPROVEMENTS.” If file sizes are too large to attach to an email, please use a file sharing service with a link to proposal in the email submission.

Submittals directed to:

Addison Canino
Asst. Public Works Director
Town of Frisco, CO
AddisonC@townoffrisco.com

The submittal of a proposal shall be taken as evidence that the proposing individual/firm has full knowledge of the scope, nature, quality and quantity of the project to be performed and the detailed requirements and conditions under which the project is to be performed.

This solicitation does not commit the Town of Frisco to award a contract, to pay any cost incurred with the preparation of a proposal, or to procure or contract for services or supplies. The Town of Frisco reserves the right to accept or reject any or all proposals received in response to this request, to negotiate with any qualified source, or cancel in whole or part this proposal process if it is in the best interest of the Town to do so. Subsequent to contract

negotiations, prospective consultants may be required to submit revisions to their proposals. All proposers should note that any contract pursuant to this solicitation is dependent upon the recommendation of the Town staff and the approval of the Frisco Town Council.

General Requirement of the Selected Proposing Firm:

- Enter into a contract with the Town. (These documents and proposal submittals become part of the contract).
- Maintain insurance coverage for the duration of the contract period.
- Prohibited from assigning or subcontracting the whole or any part of the contract without the prior written consent of the Town.
- Shall not hire, discharge, promote, demote or otherwise discriminate in matters of compensation, terms, conditions or privileges of employment against any person otherwise qualified solely because of race, creed, sex, national origin, ancestry, physical or mental disability, color or age.
- All work done by the selected firm will be in compliance with all Town of Frisco, Colorado State, Fire and American Society of Mechanical Engineering codes.
- Operate as an independent contractor and will not be considered employee(s) of the Town of Frisco.
- Successful contractor will be paid on actual invoices as work is completed.
- Performance and Payment Bonds will be required.
- Obtain a Town of Frisco Business License prior to commencement of work
- Obtain final approval signoff from Summit Fire & EMS prior to commencing construction

Selection Criteria:

The Town will select the contractor it deems best for this project with consideration to price, experience, proposed project methodology, proposed timeline, references, and other materials presented by the firm.

Exhibits:

- A. 60% Drawings
- B. Bid Tabulation Sheet

FRISCO BAY MARINA STORM DRAINAGE IMPROVEMENTS

BOAT RAMP STORMWATER PUMP STATION
TOWN OF FRISCO, COUNTY OF SUMMIT, STATE OF COLORADO


PUBLIC IMPROVEMENT CONSTRUCTION PLANS

KEY CONTACTS

OWNER:
TOWN OF FRISCO PUBLIC WORKS (970) 668-9150
102 SCHOOL ROAD
FRISCO, CO 80443
ATTN: ADDISON CANINO

CIVIL ENGINEER/SURVEYOR
JR ENGINEERING (303) 740-9393
7200 SOUTH ALTON WAY, SUITE C400
CENTENNIAL, CO 80112
ATTN: DAREN STERLING - DSTERLING@JRENGINEERING.COM

ELECTRICAL ENGINEER
EG POWER (720) 533-4850
1701 WASHINGTON AVE
GOLDEN, CO 80401
ATTN: ERIC GROMKO, PE

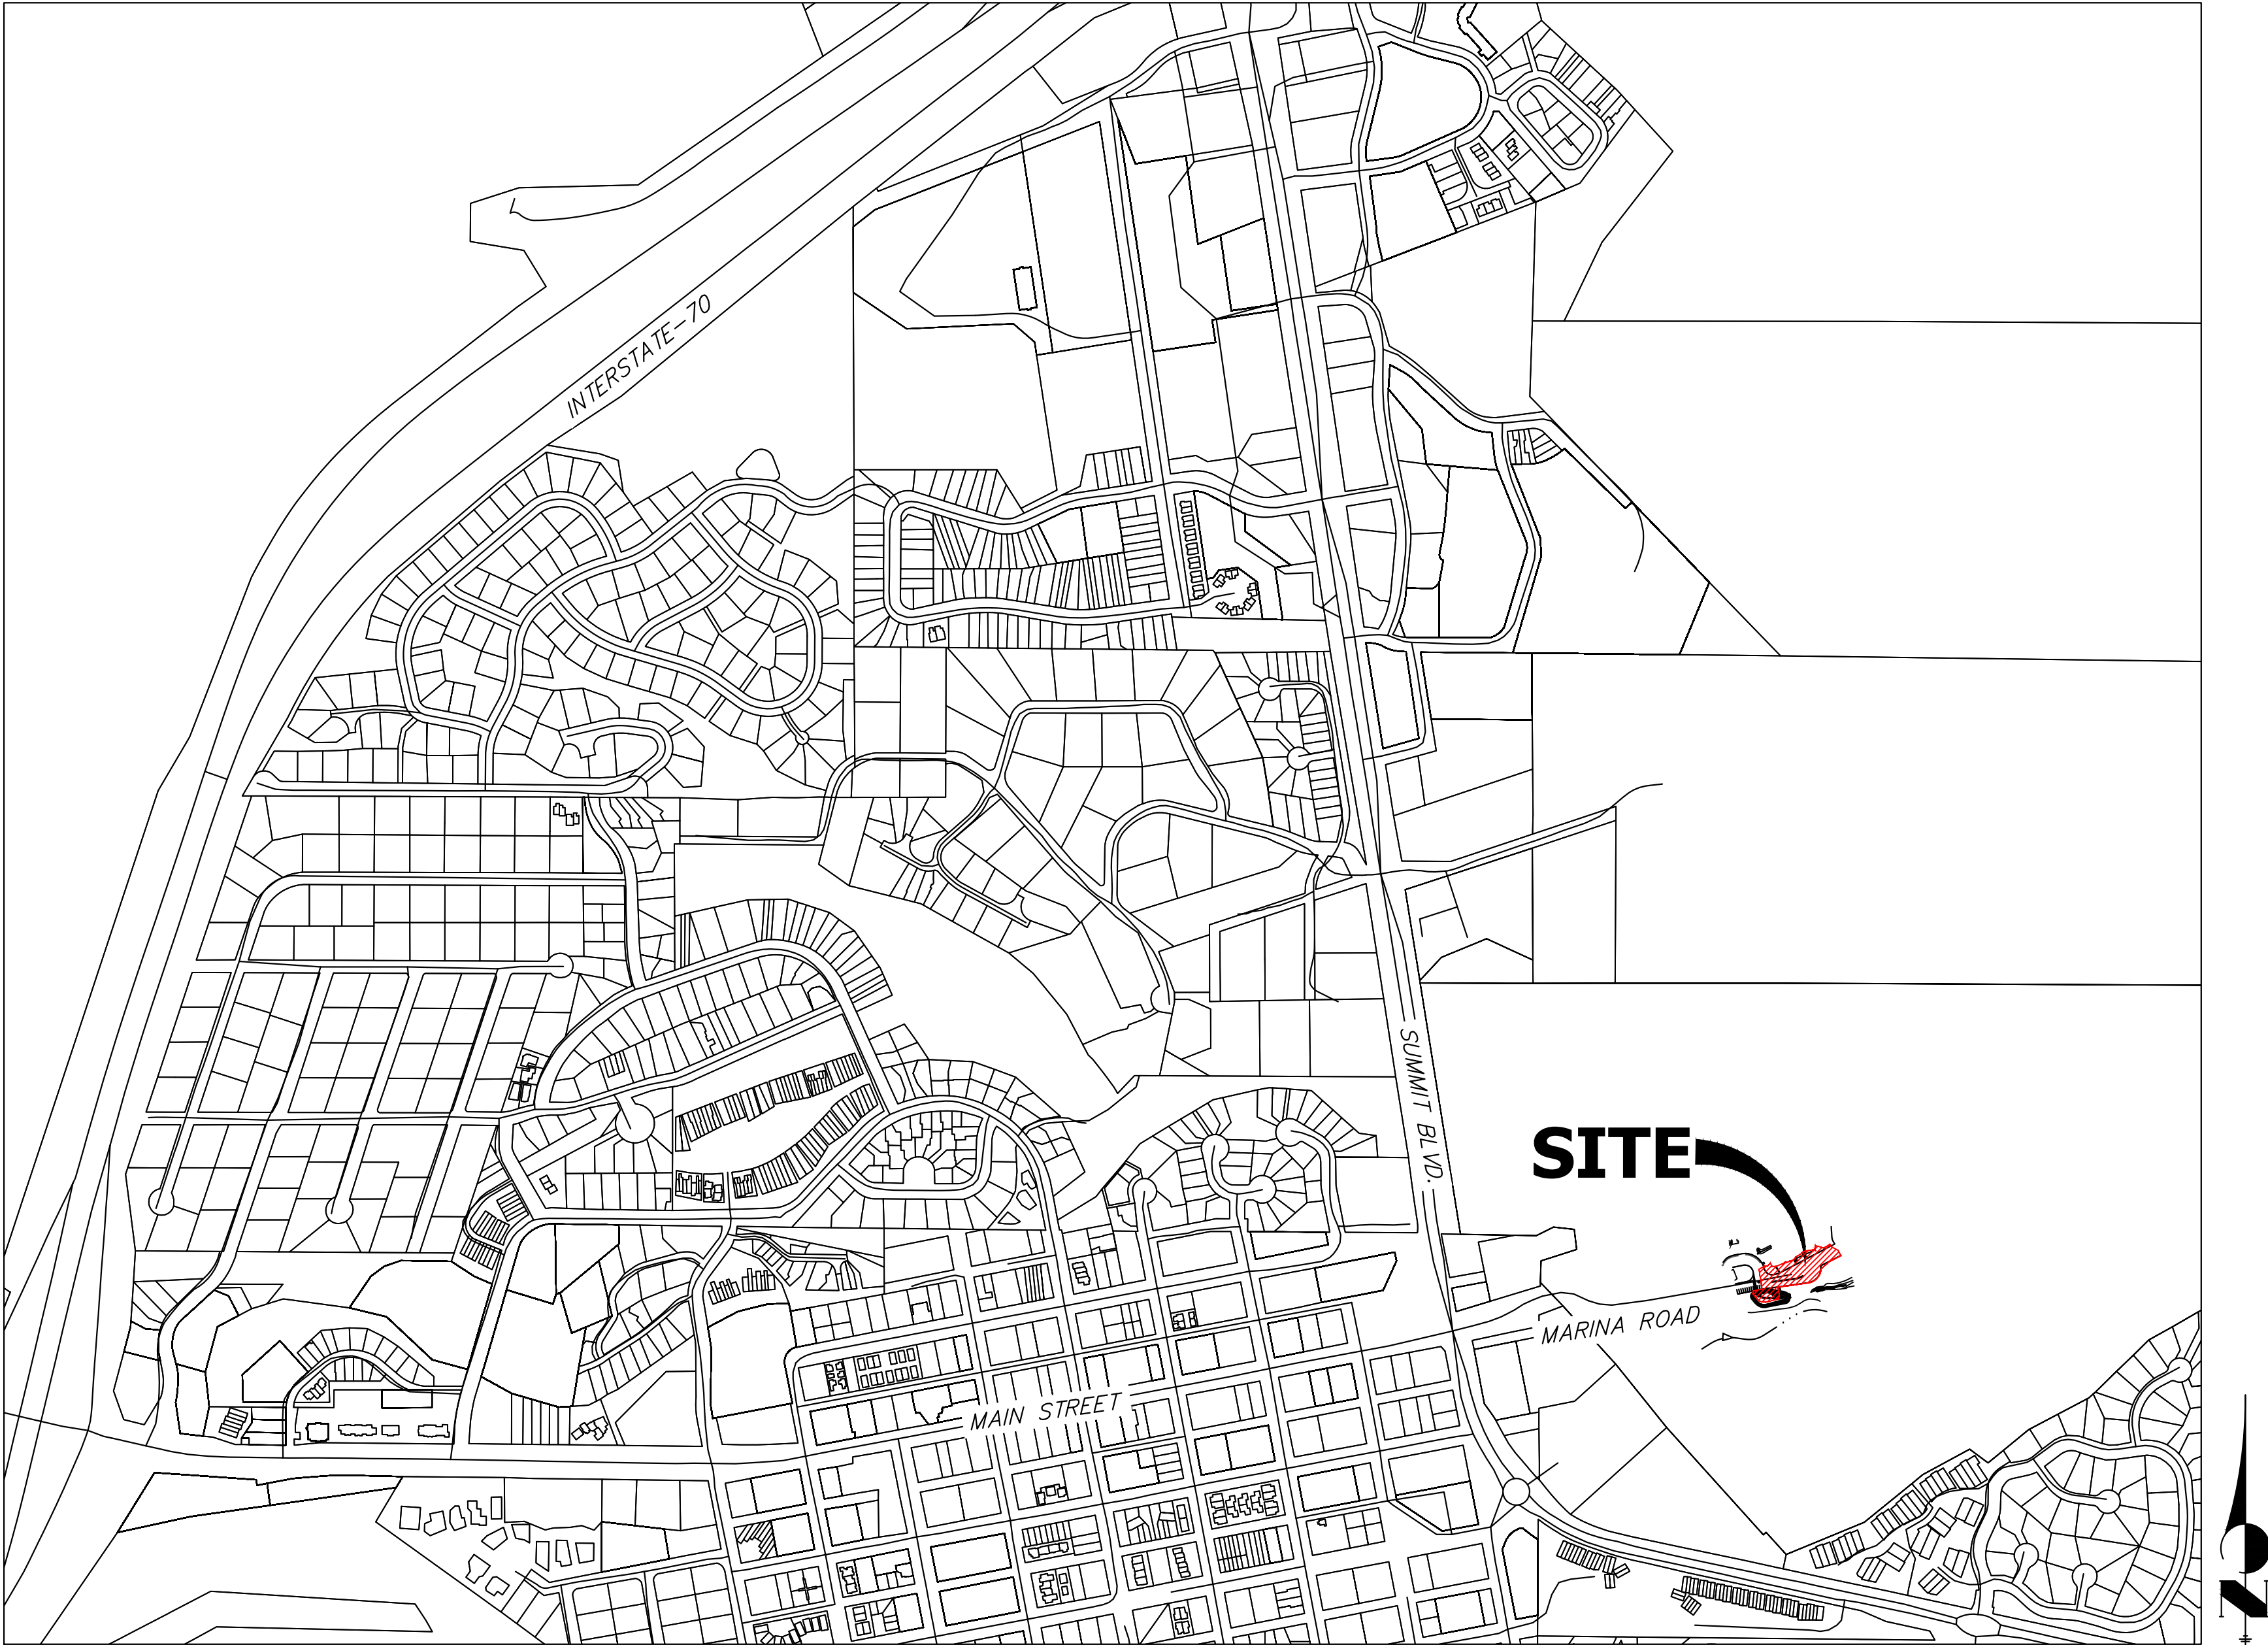

PROJECT LOCATION MAP

SCALE: 1"=500'

SHEET INDEX	
SHEET NO.	SHEET TITLE
1	COVER SHEET
2	GENERAL NOTES
3	SITE PLAN
4	DEMOLITION PLAN
5	STORM SEWER PLAN & PROFILE
6	POND GRADING PLAN
7	EROSION CONTROL PLAN
8 - 14	DETAILS
15	DRAINAGE PLAN
TOTAL - 15	

BENCHMARK:

THE BENCHMARK USED FOR THIS SITE IS NGS BM OVERLOOK, 3-1/4" ALUMINUM CAP IN CONCRETE, EAST OF ORANGE CARSONITE POST AND NORTH OF GREEN CARSONITE POST, EL=9183.16 (NAVD88).

BASIS OF BEARING:

THE EAST LINE OF SECTION 35, TOWNSHIP 5 SOUTH, RANGE 78 WEST OF THE 6TH PRINCIPAL MERIDIAN, BEING MONUMENTED BY A 3-1/4" BRASS CAP STAMPED " DMMW CO S18" AT THE NORTH END AND BY 3-1/4" BRASS CAP STAMPED "US CADASTRAL SURVEY BUREAU OF LAND MANAGEMENT T5S R78W 1/4 S35/36 1959" AT THE SOUTH END, BEARING S00°14'49"W AS REFERENCED TO COLORADO STATE PLANE CENTRAL ZONE.



ENGINEER'S STATEMENT
PREPARED UNDER

TRISTAN BONSER,
COLORADO P.E. 47602
FOR AND ON BEHALF OF JR ENGINEERING, LLC

PRELIMINARY
NOT FOR
CONSTRUCTION

FRISCO BAY MARINA STORM
DRAINAGE IMPROVEMENTS

COVER SHEET

SHEET 1 OF 15

JOB NO. 16113.00

BY DATE

No. REVISION

H-SCALE 1"=500'

V-SCALE N/A

DATE 12/30/22

DESIGNED BY AHC

DRAWN BY AHC

CHECKED BY

PREPARED FOR

TOWN OF FRISCO
PO BOX 4100
FRISCO, CO 80443
CONTACT: ADDISON CANINO
(970) 668-9150

J.R. ENGINEERING
A Western Company



Centennial 303-740-9393 • Colorado Springs 719-593-2593
Fort Collins 970-491-9888 • www.jrengineering.com

UNTIL SUCH TIME AS
THESE DRAWINGS ARE
APPROVED BY THE
APPROPRIATE REVIEWING
AGENCIES, JR ENGINEERING
APPROVES THEIR USE
FOR THE PROJECTS
DESIGNATED BY WRITTEN
AUTHORIZATION.

GENERAL NOTES

1. THE CONTRACTOR SHALL HAVE ONE SIGNED COPY OF PLANS APPROVED BY THE TOWN OF FRISCO.
2. ONE COPY OF THE APPROPRIATE DESIGN AND CONSTRUCTION STANDARDS AND SPECIFICATIONS ON THE JOB AT ALL TIMES.
3. THE CONTRACTOR SHALL NOTIFY THE OWNER, ENGINEER, AND TOWN OF FRISCO 48-HOURS PRIOR TO THE START OF CONSTRUCTION. A PRE-CONSTRUCTION MEETING SHALL BE SCHEDULED WITH THE TOWN OF FRISCO ENGINEERING INSPECTOR 48-HOURS PRIOR TO THE START OF ANY WORK.
4. THE CONTRACTOR SHALL BE SOLELY RESPONSIBLE FOR CONDITIONS AT AND ADJACENT TO THE JOB SITE, INCLUDING, BUT NOT LIMITED TO, SAFETY OF ALL PERSONS AND PROPERTY DURING PERFORMANCE OF ANY WORK. THIS REQUIREMENT SHALL APPLY TO NORMAL AND NON-NORMAL WORKING HOURS.
5. THE TOWN OF FRISCO, OWNER, AND ENGINEER CONSTRUCTION REVIEW OF THE CONTRACTOR'S PERFORMANCE IS NOT INTENDED TO INCLUDE REVIEW OF THE ADEQUACY OF THE CONTRACTOR'S SAFETY MEASURES IN, ON, OR NEAR THE CONSTRUCTION SITE.
6. ALL TRENCHES SHALL BE ADEQUATELY SUPPORTED AND THE SAFETY OF WORKERS PROVIDED FOR AS REQUIRED BY THE MOST RECENT OCCUPATIONAL SAFETY AND HEALTH ADMINISTRATION (OSHA) "SAFETY AND HEALTH REGULATIONS FOR CONSTRUCTION." THESE REGULATIONS ARE DESCRIBED IN SUBPART P, PART 1926 OF THE CODE OF FEDERAL REGULATIONS. SHEETING AND SHORING (OR APPROVED EQUAL) SHALL BE UTILIZED WHERE NECESSARY TO PREVENT ANY EXCESSIVE WIDENING OR SLOUGHING OF THE TRENCH WHICH MAY BE DETRIMENTAL TO HUMAN SAFETY, TO THE PIPE BEING PLACED, OR TO ANY EXISTING SITE IMPROVEMENTS OR STRUCTURES.
7. ALL TRENCH BACKFILL AND SUBGRADE PREPARATION SHALL BE TESTED TO ENSURE COMPLIANCE WITH GEOTECHNICAL STANDARDS AND SHALL BE TESTED BY AN APPROVED SOIL TESTING FIRM AT THE REQUIRED FREQUENCY AS SPECIFIED BY THE TOWN OF FRISCO. TEST RESULTS SHALL BE SUBMITTED TO, REVIEWED BY, AND APPROVED BY THE GEOTECHNICAL ENGINEER PRIOR TO INSTALLING APPROVED BACKFILL ON PREPARED SUBGRADE. ALL BASE COURSE DENSITY SHALL ALSO BE TESTED BY AN APPROVED SOIL TESTING FIRM AT THE REQUIRED FREQUENCY AS SPECIFIED BY THE TOWN OF FRISCO TO ENSURE COMPLIANCE. BASE COURSE TEST RESULTS SHALL ALSO BE APPROVED BY THE GEOTECHNICAL ENGINEER PRIOR TO BACKFILLING. TEST RESULTS SHALL BE REVIEWED AND APPROVED BY THE TOWN OF FRISCO ENGINEERING DIVISION PRIOR TO INITIATION OF THE REQUIRED 2-YEAR WARRANTY PERIOD.
8. CONTRACTOR SHALL CONFORM TO ALL FEDERAL, STATE, AND LOCAL HEALTH AND SAFETY RULES AND REGULATIONS.
9. THE CONTRACTOR SHALL BE RESPONSIBLE FOR PROTECTING ALL UTILITIES DURING CONSTRUCTION AND FOR COORDINATING WITH THE APPROPRIATE UTILITY COMPANY FOR ANY UTILITY CROSSINGS REQUIRED. REPAIR DAMAGED UTILITIES SHALL BE AT THE CONTRACTOR'S EXPENSE, INCLUDING BUT NOT LIMITED TO UNDERGROUND UTILITIES.
10. EXISTING FENCES, TREES, SIDEWALKS, CURBS AND GUTTERS, LANDSCAPING, STRUCTURES, AND IMPROVEMENTS DESTROYED, DAMAGED, OR REMOVED DUE TO CONSTRUCTION OF THIS PROJECT SHALL BE REPLACED OR RESTORED TO THE PRE-CONSTRUCTION CONDITION AT THE CONTRACTORS EXPENSE, UNLESS OTHERWISE INDICATED ON THESE PLANS.
11. THE CONTRACTOR SHALL OBTAIN A STORMWATER CONSTRUCTION PERMIT FROM THE COLORADO DEPARTMENT OF PUBLIC HEALTH AND ENVIRONMENT, WATER QUALITY CONTROL DIVISION, PRIOR TO CLEARING, GRADING, OR EXCAVATING A SITE OF ONE-HALF ACRE OR MORE. A COPY OF THE APPROVED PERMIT MUST BE SUBMITTED TO THE TOWN OF FRISCO PRIOR TO THE START OF CLEARING, GRADING, OR EXCAVATING. A COPY OF THE APPROVED PERMIT MUST ALSO BE AVAILABLE ON THE PROJECT SITE AT ALL TIMES DURING CONSTRUCTION.
12. IF GROUNDWATER IS ENCOUNTERED DURING EXCAVATION AND DEWATERING FROM THE TRENCH TO STORM SEWER, CHANNEL, IRRIGATION DITCH, OR ANY WATERS OF THE UNITED STATES IS NECESSARY, THE CONTRACTOR SHALL OBTAIN A COLORADO STATE CONSTRUCTION DEWATERING DISCHARGE PERMIT FROM THE COLORADO DEPARTMENT OF PUBLIC HEALTH AND ENVIRONMENT. A COPY OF THE APPROVED PERMIT MUST BE SUBMITTED TO THE TOWN OF FRISCO PRIOR TO THE START OF ANY DEWATERING. A COPY OF THE APPROVED PERMIT MUST ALSO BE AVAILABLE OF THE PROJECT SITE AT ALL TIMES DURING CONSTRUCTION.
13. THE CONTRACTOR SHALL BE RESPONSIBLE FOR REMOVING STORM RUNOFF AND ANY GROUNDWATER ENCOUNTERED DURING THE CONSTRUCTIONS OF ANY PART OF THE PROJECT. GROUNDWATER SHALL BE PUMPED, PIPED, REMOVED, AND DISPOSED OF IN A MANNER WHICH DOES NOT CAUSE FLOODING OF EXISTING STREETS NOR EROSION ON ADJACENT PROPERTIES IN ORDER TO CONSTRUCT THE IMPROVEMENTS SHOWN ON THE PLANS. NO CONCRETE SHALL BE PLACED WHERE GROUNDWATER IS VISIBLE OR UNTIL THE GROUNDWATER TABLE HAS BEEN LOWERED BELOW THE PROPOSED IMPROVEMENTS. ANY UNSTABLE AREAS, AS A RESULT OF GROUNDWATER, ENCOUNTERED DURING THE CONSTRUCTION OF THE PROPOSED IMPROVEMENTS SHALL BE STABILIZED AS AGREED UPON BY THE CONTRACTOR, THE TOWN OF FRISCO, AND THE GEOTECHNICAL ENGINEER AT THE TIME OF OCCURRENCE.
14. THE CONTRACTOR IS RESPONSIBLE FOR FIELD LOCATING AND VERIFYING ELEVATIONS OF ALL EXISTING STORM SEWER AND OTHER IMPROVEMENTS AT THE POINT OF CONNECTION SHOWN ON THE PLANS, AND AT ANY UTILITY CROSSINGS PRIOR TO INSTALLING ANY OF THE NEW IMPROVEMENTS. IF A CONFLICT EXISTS AND/OR A DESIGN MODIFICATION IS REQUIRED, THE CONTRACTOR SHALL COORDINATE WITH THE ENGINEER TO MODIFY THE DESIGN.
15. PRIOR TO THE COMMENCEMENT OF ANY CONSTRUCTION, THE CONTRACTOR SHALL CONTACT ALL UTILITIES AND COORDINATE SCHEDULES.
16. THE TOWN OF FRISCO REPRESENTATIVE SHALL BE THE TOWN OF FRISCO REPRESENTATIVE WHO SHALL HAVE THE AUTHORITY TO HALT CONSTRUCTION WHEN STANDARD CONSTRUCTION PRACTICES ARE NOT BEING ADHERED TO. THE TOWN OF FRISCO RESERVES THE RIGHT TO ACCEPT OR REJECT ANY SUCH MATERIALS AND WORKMANSHIP THAT DOES NOT CONFORM TO ITS ENGINEERING CODE OF STANDARDS AND SPECIFICATIONS FOR THE DESIGN AND CONSTRUCTION OF PUBLIC IMPROVEMENTS. CONTRACTOR IS RESPONSIBLE FOR BEING AWARE OF, NOTIFYING, COORDINATING, AND SCHEDULING ALL INSPECTIONS REQUIRED FOR FINAL APPROVALS AND PROJECT ACCEPTANCE.
17. RECORD DRAWINGS SHOWING ALL CHANGES FROM THE APPROVED CONSTRUCTION DRAWINGS SHALL BE SUBMITTED TO THE ENGINEER AND OWNER PRIOR TO INITIATION OF THE REQUIRED 2-YEAR WARRANTY PERIOD. THE RECORD DRAWINGS SHALL CONSIST OF A MARKED-UP SET OF THE CONSTRUCTION DRAWINGS VERIFYING THE FOLLOWING:
 - ALL LENGTHS, SIZES, AND MATERIALS OF INSTALLED PIPE, MANHOLES, AND ANY OTHER IMPROVEMENT
 - HORIZONTAL LOCATIONS OF ALL BENDS, VALVES, STUBS, PLUGS, TEES, ETC.
 - TOP OF PIPE AND FITTING ELEVATIONS AT REGULAR INTERVALS
 - ANY OTHER VARIATIONS FROM THE CONSTRUCTION DOCUMENTS MUST BE CLEARLY NOTED AND DETAILED ON THE PLANS.
 - AS-BUILT FIELD NOTES, FROM WHICH THE AS-BUILT DRAWINGS WILL BE PREPARED, ARE TO BE PROVIDED AND STAMPED/SIGNED AND DATED BY A COLORADO REGISTERED PROFESSIONAL LAND SURVEYOR.
18. THE CONTRACTOR SHALL WARRANT ALL WORK TO BE FREE FROM DEFECTS IN WORKMANSHIP AND MATERIALS FOR A PERIOD OF 2-YEARS FROM THE DATE OF ACCEPTANCE INTO THE WARRANTY PERIOD OF ALL CONSTRUCTION CALLED FOR BY THE PUBLIC IMPROVEMENTS AGREEMENT WITH THE TOWN OF FRISCO.
19. DURING CONSTRUCTION AND UPON COMPLETION OF CONSTRUCTION, THE SITE SHALL BE CLEANED AND RESTORED TO A CONDITION EQUAL, OR BETTER THAN, THAT WHICH EXISTED PRIOR TO CONSTRUCTION ACTIVITIES ON SITE.
20. THE OWNER SHALL IMPLEMENT A ROUTINE AND DILIGENT MAINTENANCE PLAN TO MAINTAIN PROPER GRADING AND DRAINAGE.

GRADING AND EROSION CONTROL NOTES

1. ALL SITE GRADING SHALL CONFORM TO THE RECOMMENDATIONS OF THE LATEST GEOTECHNICAL INVESTIGATION OF THIS SITE AND SHALL FURTHER BE IN CONFORMANCE WITH THE TOWN OF FRISCO'S GRADING CRITERIA, IF APPLICABLE.
2. EXISTING ELEVATIONS SHOWN ON THIS DRAWING HAVE BEEN DEPICTED FROM THE BEST AVAILABLE INFORMATION AND ARE SHOWN TO THE EXTENT KNOWN. IT IS THE RESPONSIBILITY OF THE CONTRACTOR TO FIELD VERIFY EXISTING GRADE CONDITIONS AT THE LIMITS OF CONSTRUCTION AND AT LOCATIONS THAT INTERFERE WITH EXISTING OR PROPOSED STRUCTURES AND NOTIFY THE ENGINEER OF ANY DISCREPANCIES THAT CONTRADICT THE ENGINEERS INTENT FOR THE DRAINAGE PATTERNS, MAXIMUM AND MINIMUM SLOPES, AND PROPOSED ELEVATIONS AS SHOWN ON THE PLAN. THE ENGINEER WILL NOT BE LIABLE FOR ANY COSTS ASSOCIATED WITH THE CHANGES TO THE DESIGN WITHOUT PROPER NOTIFICATION.
3. PROPOSED CONTOURS AND SPOT ELEVATIONS AS SHOWN HEREIN ARE DEFINED AS FINISHED ELEVATION AFTER PAVING, LANDSCAPING, ETC. CONTRACTOR SHALL COORDINATE WITH GEOTECH FOR PAVEMENT THICKNESS AND LANDSCAPE THICKNESS OF TOPSOIL, SOD, AND LANDSCAPE MATERIALS.
4. TEMPORARY CUT/FILL SLOPES SHALL NOT EXCEED A STEEPNESS OF [1:1] (H:V). PERMANENT SLOPES SHALL NOT EXCEED 2:1 (H:V) UNLESS NOTED OTHERWISE.
5. CONTRACTOR SHALL ADJUST ALL EXISTING AND PROPOSED MANHOLE RIMS, VALVE BOXES, ETC. TO MATCH FINAL GRADE.
6. THE CONTRACTOR SHALL PREPARE, SUBMIT, AND ACQUIRE A COLORADO DEPARTMENT OF PUBLIC HEALTH AND THE ENVIRONMENT EROSION CONTROL PLAN AND PERMIT PRIOR TO BEGINNING ANY SITE DISTURBING ACTIVITY. IF DISTURBING GREATER THAN ONE ACRE OF LAND AS PART OF THIS PROJECT, CONTRACTOR SHALL PROVIDE PAYMENT FOR ALL PERMIT FEES.
7. CONTRACTOR SHALL INSTALL AND MAINTAIN EROSION/SEDIMENTATION CONTROL DURING CONSTRUCTION, FOR ANY TIME OF YEAR, IN ACCORDANCE WITH THE CDPHE EROSION PREVENTION AND SEDIMENT CONTROL REQUIREMENTS, THE STANDARD CONSTRUCTION SPECIFICATIONS FOR THIS PROJECT AND THE EROSION CONTROL NOTES INCLUDED WITHIN THESE PLANS. IF DISCREPANCIES BETWEEN STANDARDS OCCUR, THE MORE STRINGENT REGULATION SHALL APPLY.
8. APPROVAL OF THE EROSION CONTROL PLAN DOES NOT CONSTITUTE AN APPROVAL OF PERMANENT DRAINAGE DESIGN.
9. THE IMPLEMENTATION OF THE EROSION CONTROL PLANS AND THE CONSTRUCTION, MAINTENANCE, REPLACEMENT, AND UPGRADING OF THESE FACILITIES IS THE RESPONSIBILITY OF THE CONTRACTOR UNTIL ALL CONSTRUCTION IS COMPLETED AND APPROVED AND VEGETATION/LANDSCAPING IS ESTABLISHED.
10. THE BOUNDARIES OF THE LIMITS OF CONSTRUCTION SHALL BE CLEARLY FLAGGED IN THE FIELD PRIOR TO CONSTRUCTION. DURING THE CONSTRUCTION PERIOD, NO DISTURBANCE BEYOND THE FLAGGED LIMITS OF CONSTRUCTION SHALL BE PERMITTED. THE FLAGGING SHALL BE MAINTAINED BY THE CONTRACTOR FOR THE DURATION OF CONSTRUCTION.
11. EROSION CONTROL FACILITIES MUST BE CONSTRUCTED IN CONJUNCTION WITH ALL CLEARING AND GRADING ACTIVITIES, AND IN SUCH A MANNER AS TO ENSURE THAT SEDIMENT AND/OR SEDIMENT LADEN WATER DOES NOT ENTER THE DRAINAGE SYSTEM.
12. THE EROSION CONTROL FACILITIES SHALL BE INSPECTED DAILY BY THE CONTRACTOR AND MAINTAINED AS NECESSARY TO ENSURE THEIR CONTINUED FUNCTIONALITY.
13. THE EROSION CONTROL FACILITIES ON INACTIVE SITES SHALL BE INSPECTED AND MAINTAINED A MINIMUM OF ONCE A MONTH OR WITHIN 24 HOURS FOLLOWING A STORM EVENT.
14. STABILIZED CONSTRUCTION ENTRANCES SHALL BE INSTALLED AT THE BEGINNING OF CONSTRUCTION AND MAINTAINED FOR THE DURATION OF THE PROJECT. ADDITIONAL MEASURES MAY BE REQUIRED TO ENSURE THAT ALL PAVED AREAS ARE KEPT CLEAN FOR THE DURATION OF THE PROJECT.
15. CONTRACTOR SHALL PROVIDE DUST CONTROL AS REQUIRED.
16. SEEDING SHALL BE PERFORMED NO LATER THAN SEPTEMBER 1 FOR EACH PHASE OF CONSTRUCTION. ROUGHEN AND SEED ALL DISTURBED SURFACES.
17. EROSION CONTROL MEASURES SHALL BE REMOVED BY THE CONTRACTOR WHEN VEGETATION IS FULLY ESTABLISHED.
18. CONTRACTOR SHALL PROVIDE AND MAINTAIN A CONCRETE WASHOUT FACILITY.

STORM SEWER GENERAL NOTES

1. ALL STORM SEWER PIPE SHALL BE ASTM C76 CLASS III REINFORCED CONCRETE PIPE (RCP) UNLESS OTHERWISE SPECIFIED IN THESE PLANS.
2. ALL STORM SEWER MANHOLES SHALL BE 1/4 INCH LOW TO FLUSH WITH FINAL PAVED SURFACE.
3. PRIOR TO INITIAL ACCEPTANCE OF PUBLIC IMPROVEMENTS, THE TOWN MAY REQUIRE THE APPLICANT OR HIS CONTRACTOR TO FILE A MAINTENANCE BOND WITH THE CITY IN THE AMOUNT OF FIFTEEN (15) PERCENT OF THE ESTIMATED COST OF CONSTRUCTION OR AN AMOUNT ADEQUATE TO ENSURE THE SATISFACTORY MAINTENANCE AND CONDITION OF THE REQUIRED PUBLIC IMPROVEMENTS FOR A PERIOD OF ONE (1) YEAR AFTER THE DATE OF THEIR FINAL ACCEPTANCE AND DEDICATION TO THE CITY.
4. THE CONTRACTOR SHALL FURNISH AND INSTALL, PER SPECIFICATIONS, THE APPROPRIATE BURIED UTILITY WARNING AND IDENTIFICATION TAPE ABOVE ALL PUBLIC SEWER LINES, INCLUDING SEWER LATERALS LOCATED IN PUBLIC RIGHTS-OF-WAY.
5. AFTER COMPLETION OF PIPE LAYING, ALL MAIN LINE SEWERS, SERVICE LATERALS AND STRUCTURES SHALL BE TESTED IN THE PRESENCE OF THE INSPECTOR. IT WILL BE THE PERMITTEE'S RESPONSIBILITY TO PAY FOR THE COST OF THIS WORK.
6. COMPACTION TESTS SHALL BE SUPPLIED BY CONTRACTOR FOR ALL TRENCHES.
7. BEDDING FOR THE RCP PIPE SHALL BE A67122 NO. 57/67 CRUSHED ROCK. SQUEEGEE OR MIXTURES CONTAINING SQUEEGEE SHALL NOT BE USED. BEDDING SHALL BE SIX TO EIGHT INCHES DEEP UNDER THE PIPE AND BACKFILLED TO THE SPRING LINE.
8. REQUEST FOR AN INSPECTION OF REINFORCEMENT AND SUBGRADE MUST BE CALLED 24 HOURS PRIOR TO PLACEMENT OF CONCRETE AT MANHOLES AND INLETS. STORM SEWER INSTALLATION SHALL BE SUBJECTED TO ADDITIONAL PERIODIC INSPECTION BY THE ENGINEER. FOR STORM SEWER IN THE ROADWAY AREA, TRENCH COMPACTION SHALL BE IN ACCORDANCE WITH AASHTO T99 OR T180 AS REQUIRED IN SECTION 203.11 OF THE CDOT STANDARD SPECIFICATIONS. COMPACTION TESTS MUST BE PERFORMED BY A GEOTECHNICAL ENGINEER AND SHALL BE A MINIMUM OF EVERY 250 FEET ALONG THE TRENCH. TESTING INTERVALS MAY BE INCREASED AT THE DISCRETION OF THE CITY INSPECTOR.

LAYER LINETYPE LEGEND

	EXISTING	PROPOSED
MATCH LINE		
BOUNDARY LINE		
PROPERTY LINE		
EASEMENT LINE		
RIGHT OF WAY		
CENTERLINE		
WIRE FENCE		
CHAIN LINK FENCE		
WOOD FENCE		
MASONRY FENCE		
CABLE TV		
ELECTRIC		
FIBER OPTIC		
OVERHEAD UTILITY		
STORM DRAIN		
TELEPHONE		
SWALE/WATERWAY FLOWLINE		
MAJOR DRAINAGE BASIN		
MINOR DRAINAGE BASIN		
TOP OF SLOPE		
TOE OF SLOPE		
EDGE OF WATER		
INDEX CONTOUR		
INTERMEDIATE CONTOUR		
DEPRESSION CONT. (INDEX)		
DEPRESSION CONT. (INTER)		
SILT FENCE		
100 YEAR FLOODPLAIN		
500 YEAR FLOODPLAIN		
FLOODWAY		
BASE FLOOD ELEVATION		
EDGE OF WETLANDS		

UTILITIES LEGEND

	EXISTING	PROPOSED
STORM SEWER		
MANHOLE		
STORM INLET		
AREA INLET - SQUARE		
AREA INLET - ROUND		
FLARED END SECTION		
RIPRAP		
DRY UTILITIES		
CABLE TV MARKER		
CABLE TELEVISION PEDESTAL		
FIBER-OPTIC MARKER		

DRAINAGE PLANS

BASIN DESIGNATION (1 COEFFICIENT)	
DRAINAGE POINT IDENTIFIER (TRIANGULAR)	

LANDSCAPE LEGEND

	EXISTING
TREE	
BOLLARD	

UNTIL SUCH TIME AS THESE DRAWINGS ARE APPROVED BY THE APPROPRIATE REVIEWING AGENCIES, OR ENGINEERING APPROVES THEIR USE, THESE DRAWINGS ARE DESIGNATED BY WRITTEN AUTHORIZATION.

PREPARED FOR
TOWN OF FRISCO
PO BOX 4100
FRISCO, CO 80443
CONTACT: ADDISON CANINO
(970) 668-9150

J.R. ENGINEERING
A Westman Company

Central 303-740-9988 • Colorado Springs 719-583-2593
Fort Collins 970-491-9988 • www.jrengineering.com

FRISCO BAY MARINA STORM DRAINAGE IMPROVEMENTS	GENERAL NOTES	SHEET 2 OF 15	JOB NO. 16113.00
REVISION	BY	DATE	
No.	N/A	N/A	
	N/A	N/A	
	12/30/22	AHC	
	DESIGNED BY	AHC	
	DRAWN BY	AHC	
H-SCALE	V-SCALE	DATE	
	DESIGNED BY	AHC	
	DRAWN BY	AHC	
	CHECKED BY		




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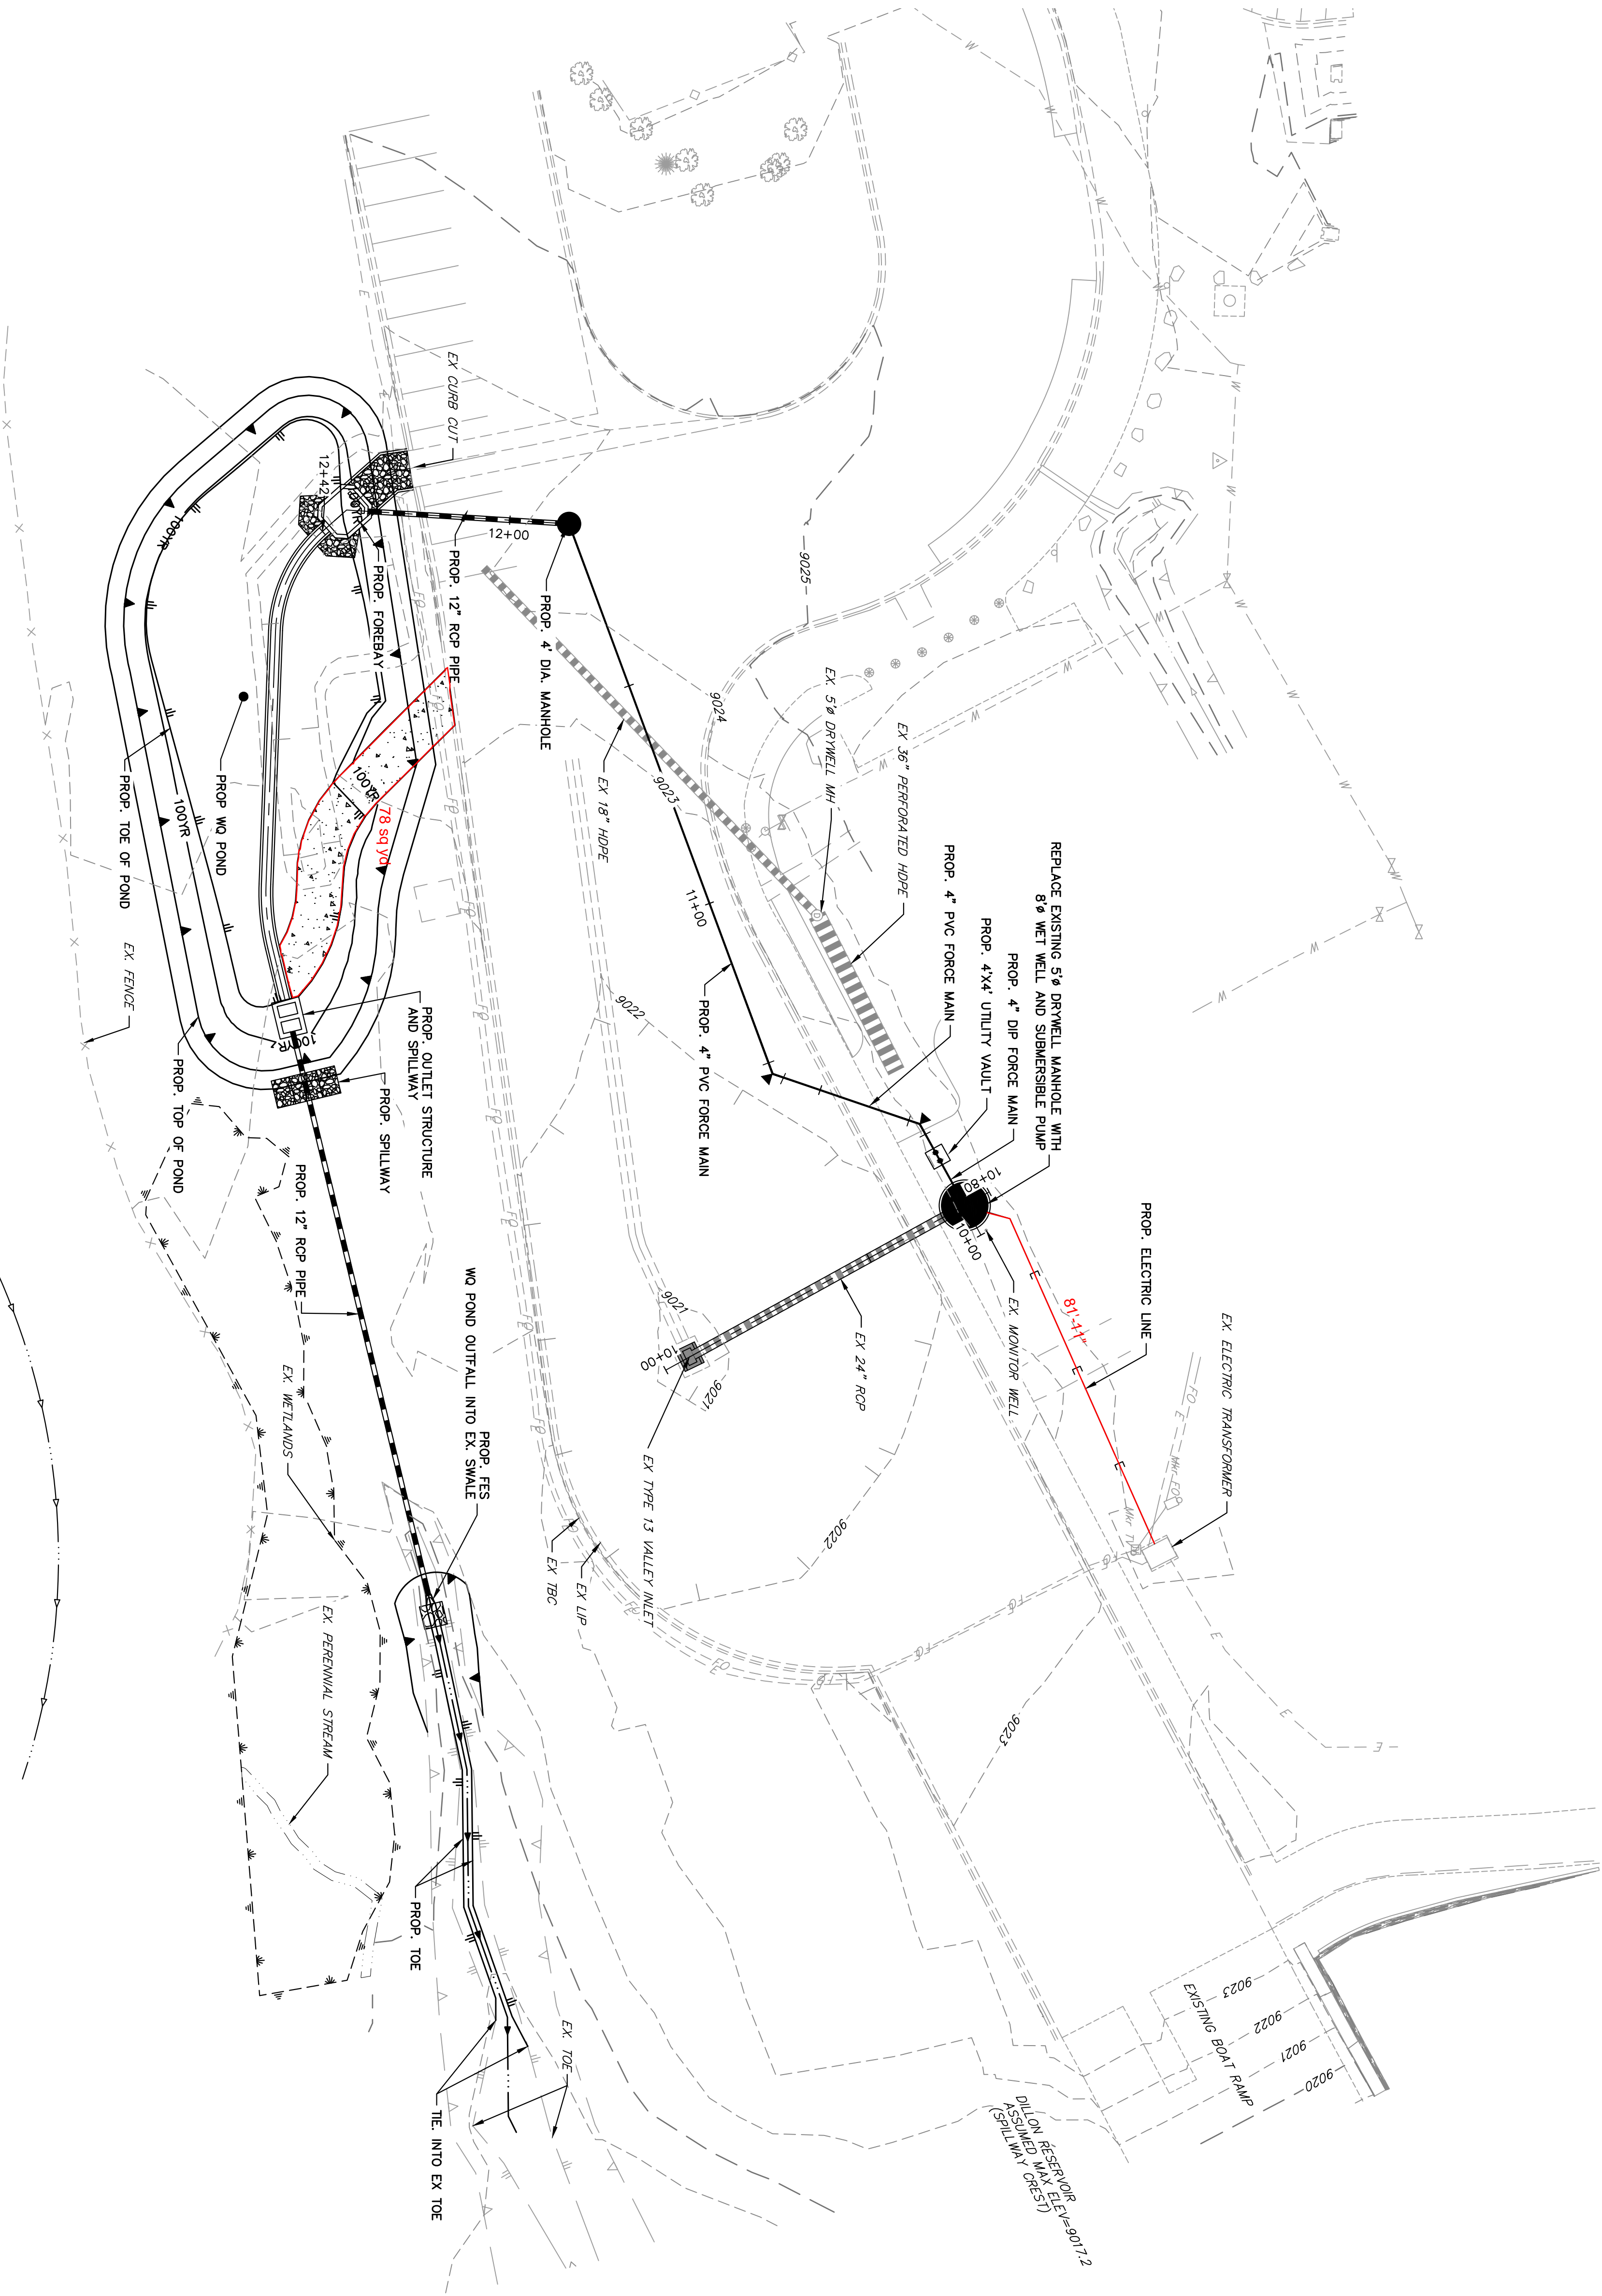
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COLORADO P.E. 4760
FOR AND ON BEHALF OF JR ENGINEERING, LLC






BENCHMARK:


THE BENCHMARK USED FOR THIS SITE IS NGS. BM OVERLOOK, 3-1/4" ALUMINUM CAP IN CONCRETE, EAST OF ORANGE CARSONITE POST AND NORTH OF GREEN CARSONITE POST, EL=9183.16 (NAVD83).

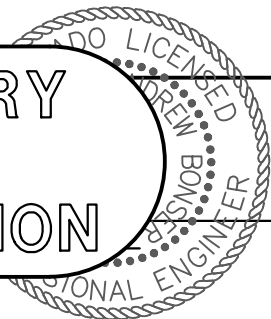BASIS OF BEARING:

THE EAST LINE OF SECTION 35, TOWNSHIP 5 SOUTH, RANGE 78 WEST OF THE 6TH PRINCIPAL MERIDIAN, BEING MONUMENTED BY A 3-1/4" BRASS CAP STAMPED "DMMW CO S167" AT THE NORTH END AND BY 3-1/4" BRASS CAP STAMPED "US CADASTRAL SURVEY BUREAU OF LAND MANAGEMENT T5S. R78W 1/4. S35/36 1959" AT THE SOUTH END, BEARING S001°49'W AS REFERENCED TO COLORADO STATE PLANE, CENTRAL ZONE.

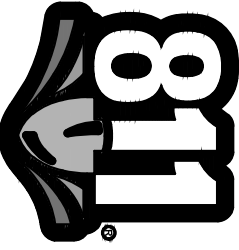

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

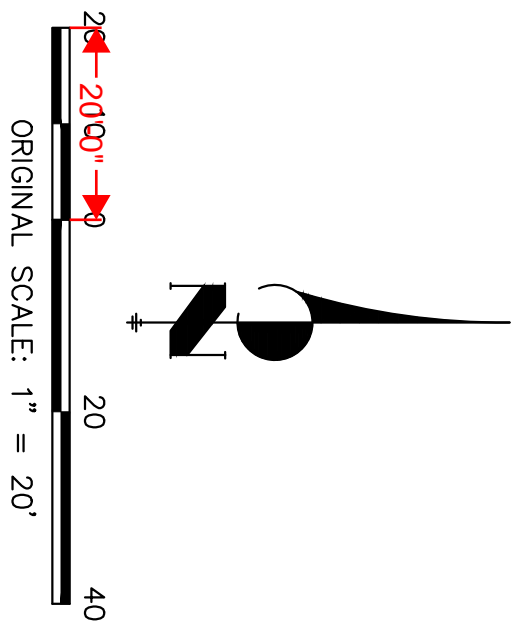
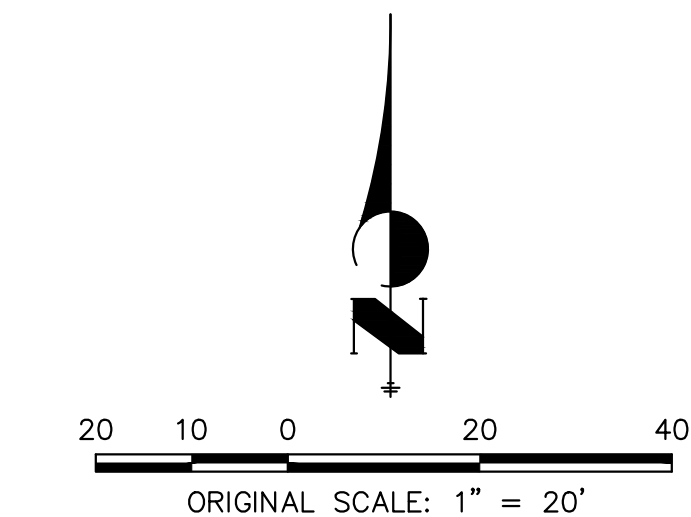
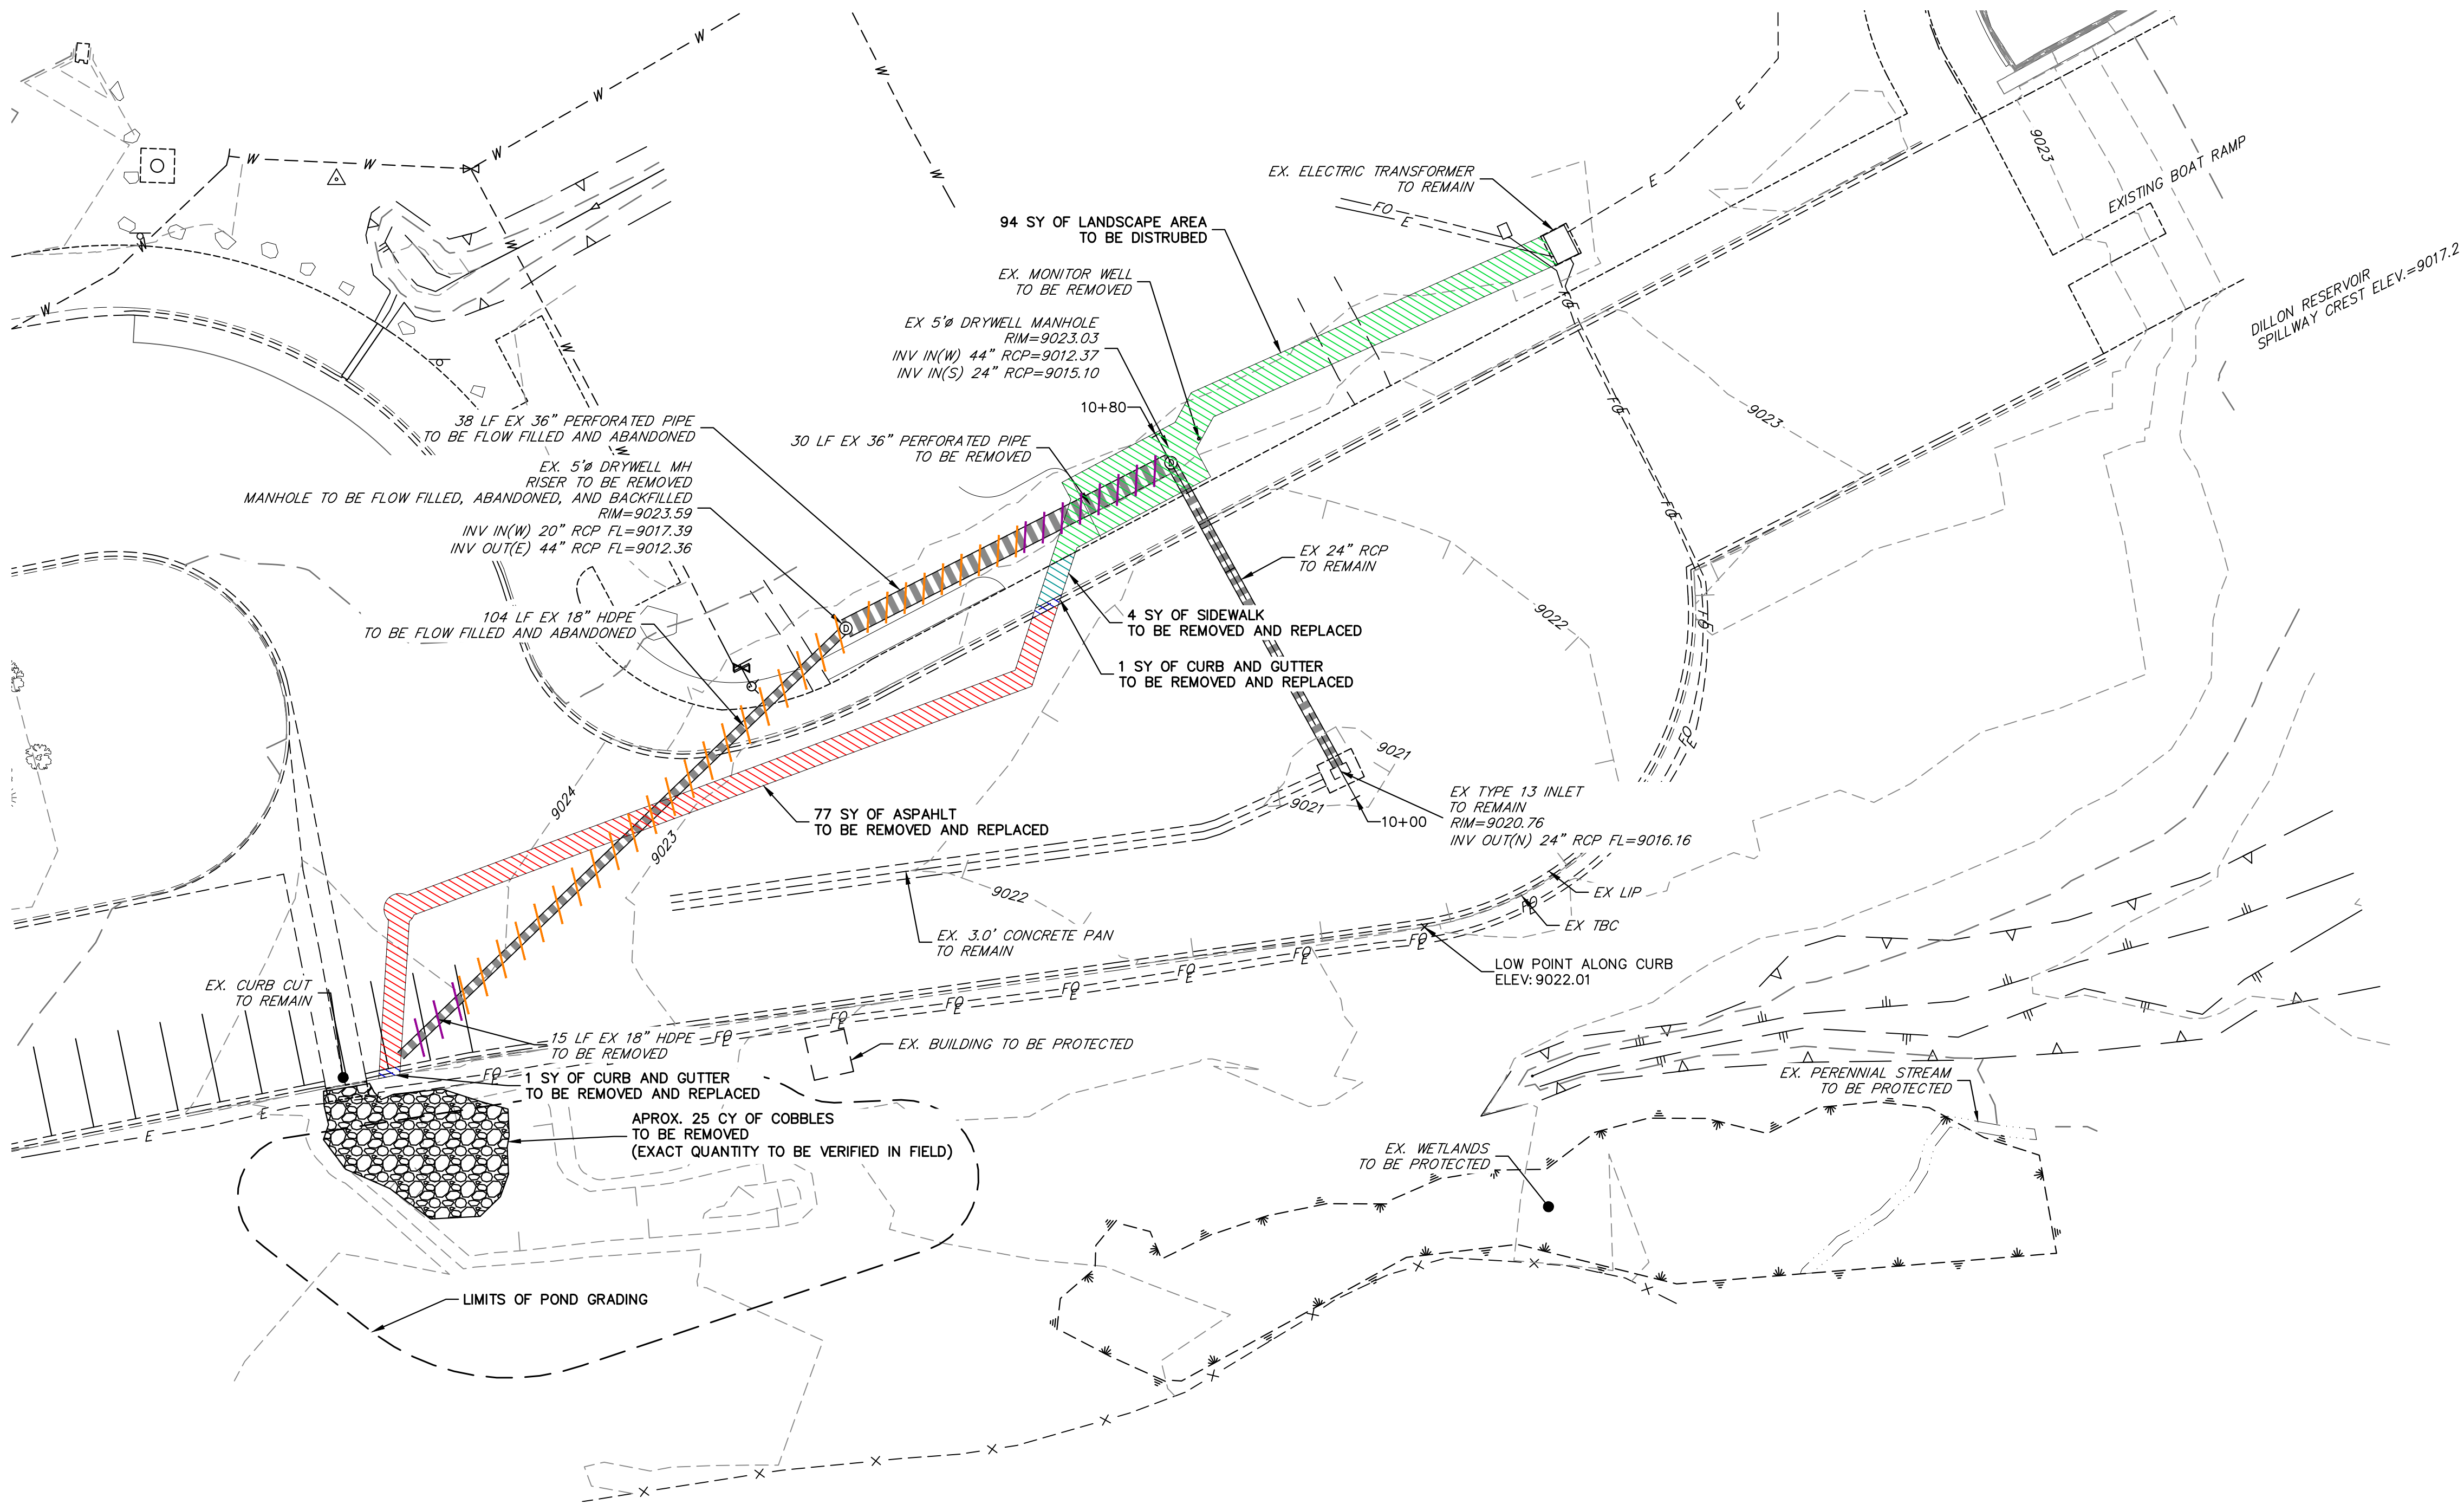
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TRISTAN ROUSSEAU
COLORADO REG. #14780
FOR AND ON BEHALF OF JR ENGINEERING, LLC

JOB NO. 16113.00	SHEET 3 OF 15	FRISCO BAY MARINA STORM DRAINAGE IMPROVEMENTS SITE PLAN	H-SCALE	1"=20'	No.	REVISION	BY	DATE	 J-R ENGINEERING A Westrian Company Centennial 303-740-9393 • Colorado Springs 719-593-2593 Fort Collins 970-491-9888 • www.jrengineering.com	PREPARED FOR TOWN OF FRISCO PO BOX 4100 FRISCO, CO 80443 CONTACT: ADDISON CANINO (970) 668-9150	UNTIL SUCH TIME AS THESE DRAWINGS ARE APPROVED BY THE APPROPRIATE REVIEWING AGENCIES, JR ENGINEERING APPROVES THEIR USE ONLY FOR THE PURPOSES DESIGNATED BY WRITTEN AUTHORIZATION.
			V-SCALE	N/A							
			DATE	12/30/22							
			DESIGNED BY	AHC							
			DRAWN BY	AHC							
			CHECKED BY								



LEGEND	
	LANDSCAPE AREA TO BE DISTURBED
	ASPHALT AREA TO BE REMOVED AND REPLACED
	CURB AND GUTTER TO BE REMOVED AND REPLACED
	SIDEWALK TO BE REMOVED AND REPLACED
	LINEAR PIPE REMOVAL
	LINEAR PIPE FLOW FILL

BENCHMARK.
THE BENCHMARK USED FOR THIS SITE IS NGS BM OVERLOOK, 3-1/4" ALUMINUM CAP IN CONCRETE, EAST OF ORANGE CARSONITE POST AND NORTH OF GREEN CARSONITE POST, EL=9183.16 (NAVD88).

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PREPARED UNDER

TRISTAN BONSER,
COLORADO P.E. 4760,
FOR AND ON BEHALF OF JR ENGINEERING, LLC



FRISCO BAY MARINA STORM
DRAINAGE IMPROVEMENTS

DEMOLITION PLAN

SHEET 4 OF 15
JOB NO. 16113.00

REVISION		BY		DATE	
No.					
1"	20'				
H-SCALE	N/A				
V-SCALE	12/30/22				
DATE	AHC				
DESIGNED BY	AHC				
DRAWN BY					
CHECKED BY					


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LEGEND

EXISTING CONTOUR		LIMITS OF CONSTRUCTION		INLET PROTECTION	
PROPOSED CONTOUR		DRAINAGE SWALE		PERMANENT SEEDING AND MULCHING - NATIVE REVEGETATION SEED MIX*	
EXISTING STORM SEWER		CONSTRUCTION FENCE		PERMANENT LANDSCAPING (DONE BY OTHERS)	
PROPOSED STORM SEWER		SILT FENCE		AREA TO BE PROTECTED	
PROPOSED TOP OF SLOPE		VEHICLE TRACKING CONTROL		CONCRETE WASHOUT AREA	
PROPOSED TOE OF SLOPE		STABILIZED STAGING AREA			
EXISTING DRAINAGE ARROW					
PROPOSED DRAINAGE ARROW					



SUMMARY OF EROSION CONTROL QUANTITIES


1	EA	-	CONCRETE WASHOUT AREA (CWA)
1100	LF	-	CONSTRUCTION FENCE (CF)
1	EA	-	INLET PROTECTION (IP)
61	EA	-	SILT FENCE (SF)
1	EA	-	STABILIZED STAGING AREA (SSA)
1	EA	-	VEHICLE TRACKING CONTROL (VTC)
0.5	AC	-	SEEDING AND MULCHING (SM)

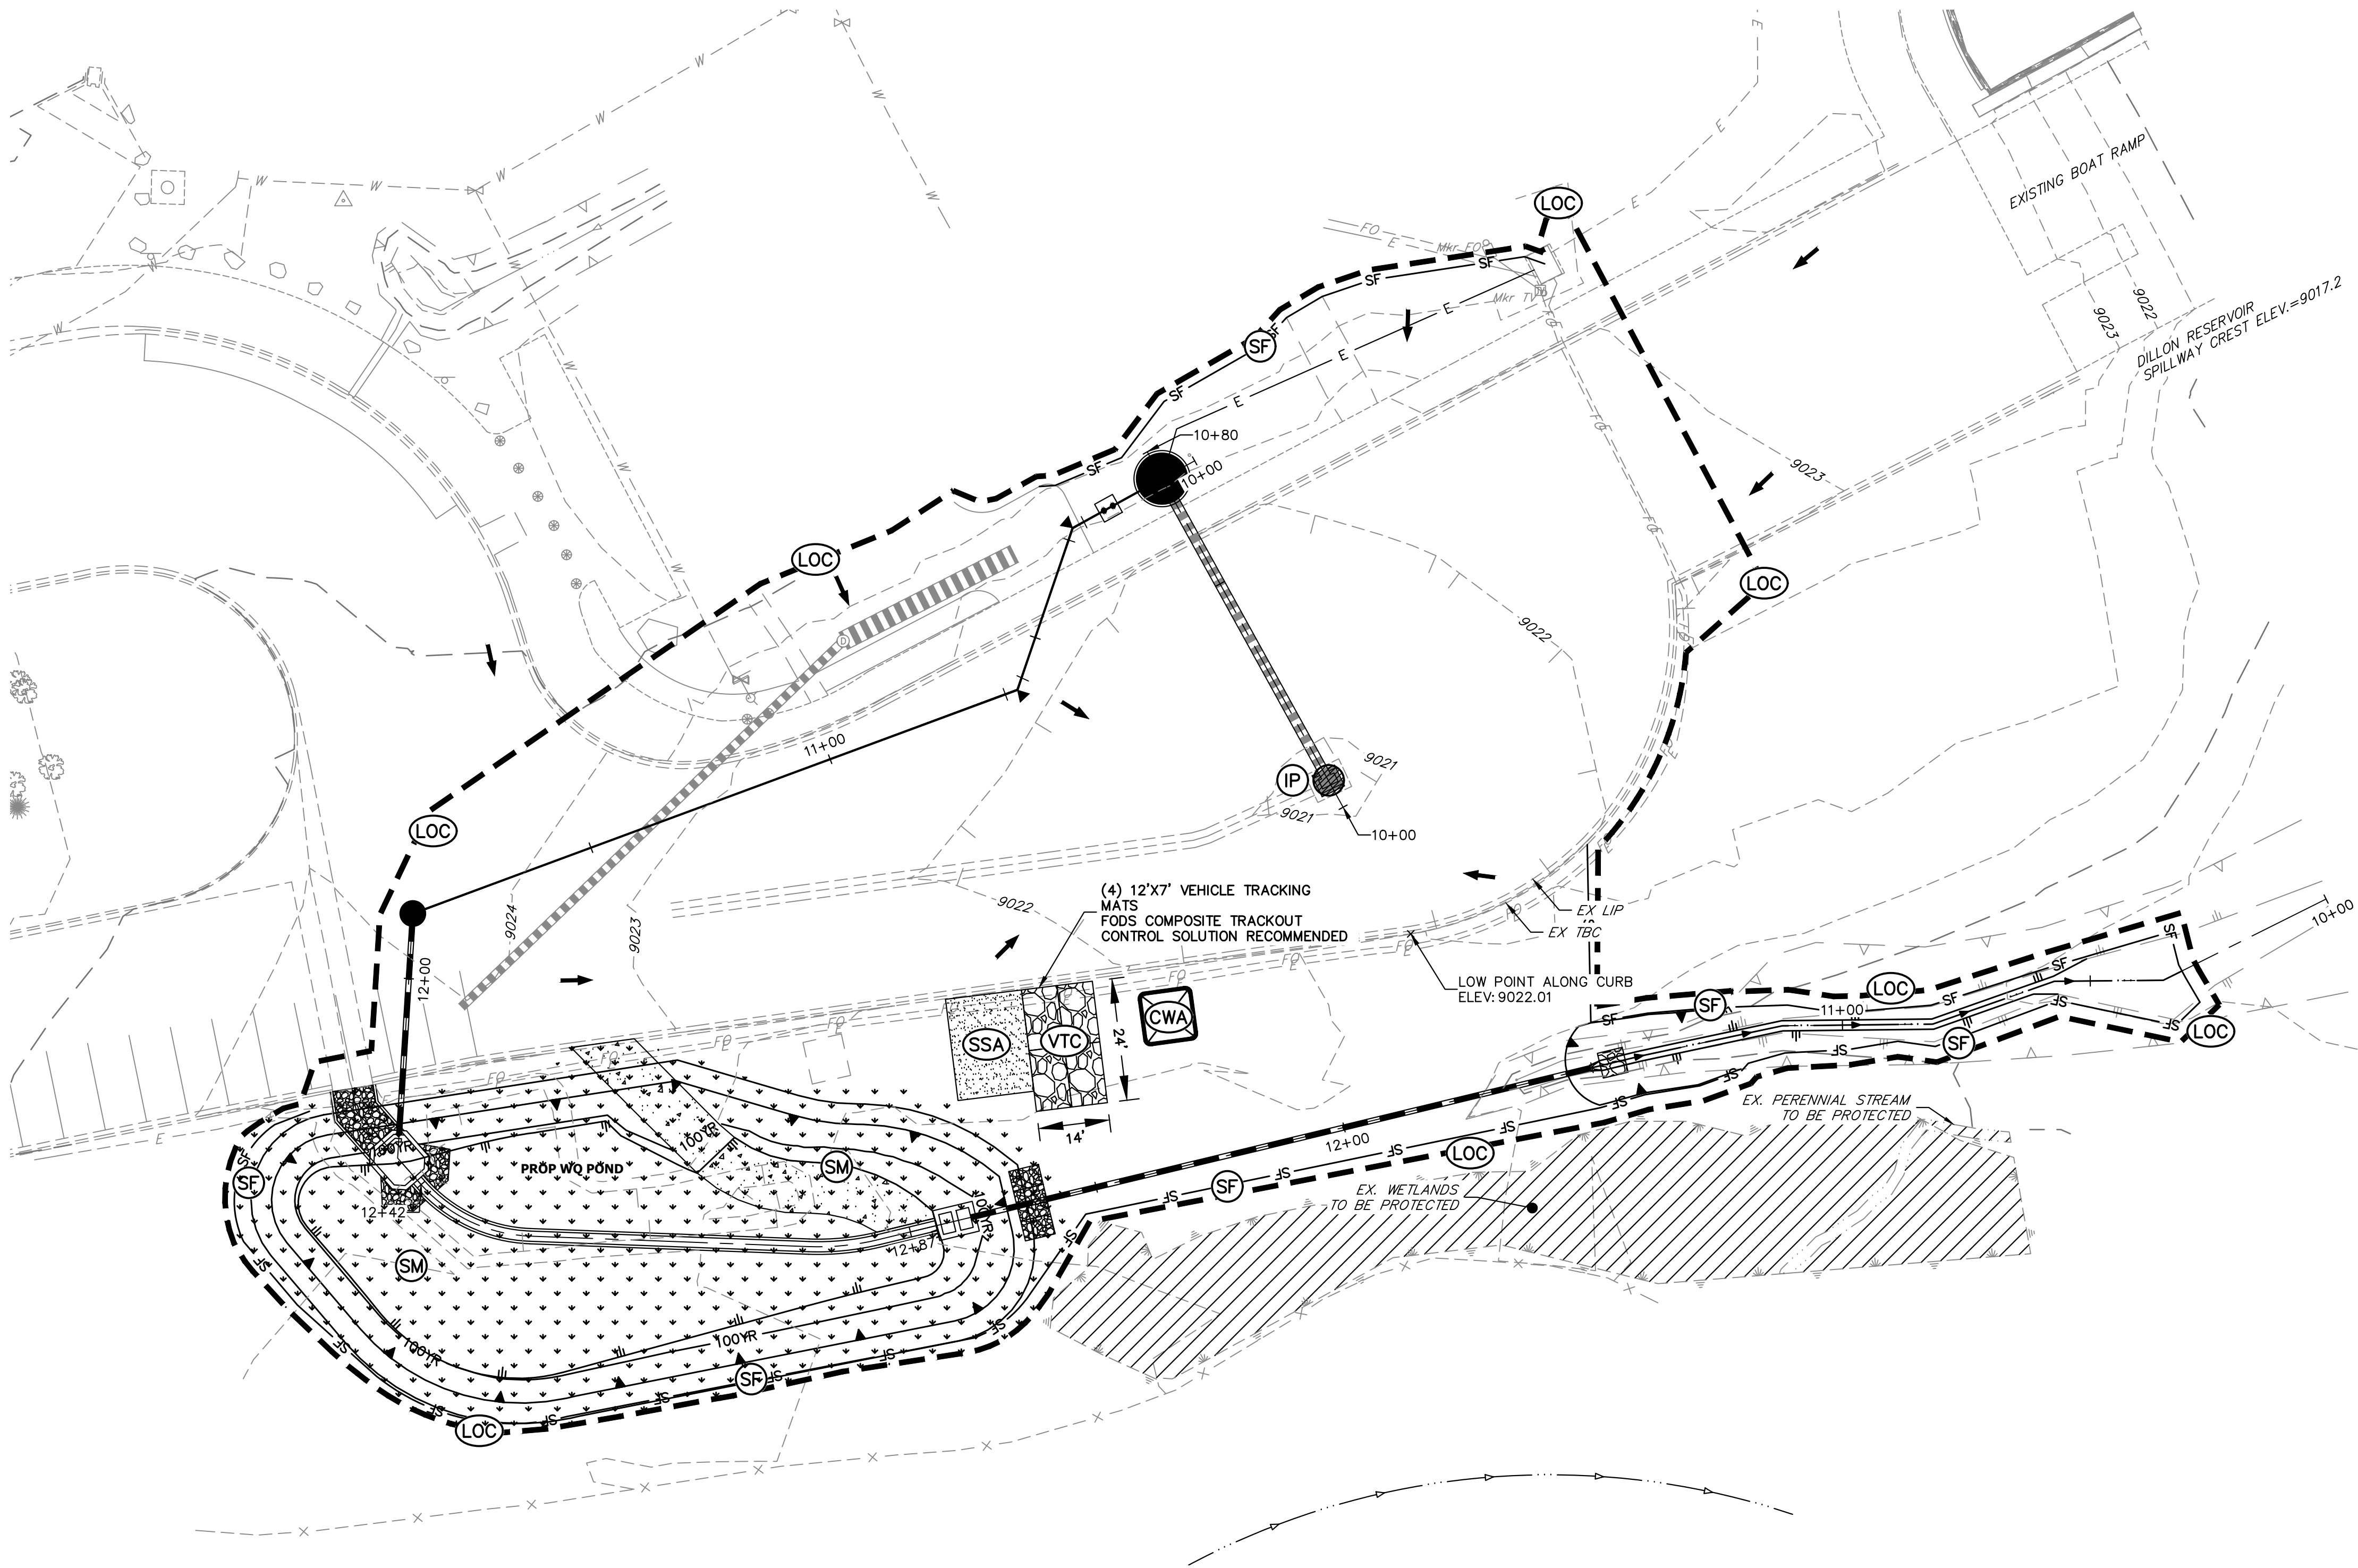BMP PHASING

- INITIAL
- 1) INSTALL VTC
 - 2) LOCATE/INSTALL CWA
 - 3) ESTABLISH SSA
 - 4) INSTALL SILT FENCE
 - 5) INSTALL CONSTRUCTION MARKERS
- INTERIM
- 1) MAINTAIN ALL BMPs
 - 2) INSTALL INLET AND OUTLET PROTECTION
- FINAL
- 1) PERMANENT SEEDING AND MULCHING
 - 2) REMOVE VTC, CWA, AND SSA
 - 3) REMOVE TEMPORARY SILT FENCE AFTER STABILIZATION

GESC NOTES

1. APPROPRIATE CONTROL MEASURES MUST BE IMPLEMENTED PRIOR TO THE START OF LAND DISTURBANCE ACTIVITY. MUST CONTROL POTENTIAL POLLUTANTS DURING EACH PHASE OF CONSTRUCTION, AND MUST BE CONTINUED THROUGH FINAL STABILIZATION. APPROPRIATE STRUCTURAL AND NON-STRUCTURAL CONTROL MEASURES MUST BE MAINTAINED IN OPERATIONAL CONDITION.
2. SEE STANDARD NOTES AND DETAILS FOR LEGEND OF NAMES AND SYMBOLS.
3. ALL INTERIM CONTROL MEASURES, INCLUDING SEEDING AND MULCHING OR DISTURBED AREAS, MUST BE COMPLETED WITHIN 14 DAYS IF THE AREAS WILL REMAIN UNDISTURBED FOR A PERIOD GREATER THAN 30 DAYS.
4. ACCEPTANCE OF THE POST-CONSTRUCTION PERMANENT CONTROL MEASURES WILL NOT OCCUR UNTIL ALL TRIBUTARY AREAS TO THE PERMANENT CONTROL MEASURES ARE FINAL STABILIZED.
5. SEEDING AREAS ARE EXPECTED TO BE BLANKETED VS. USING A STRAW MULCH AND TACKIFIER DUE TO STEEP SLOPES.

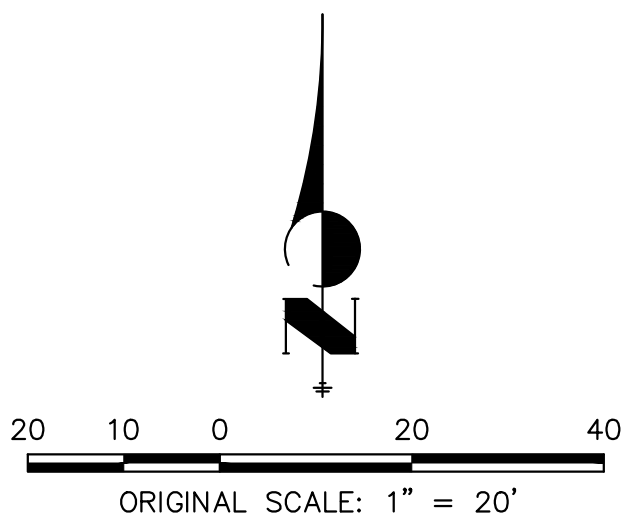

BENCHMARK.

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CONSTRUCTION

FRISCO BAY MARINA STORM
DRAINAGE IMPROVEMENTS
EROSION CONTROL PLAN

SHEET 7 OF 15

JOB NO. 16113.00

PREPARED FOR
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FRISCO, CO 80443
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(970) 668-9150

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A Western Company



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Diagram showing a detail of a rebar lap joint. The joint is labeled "ROUGHENED CONST. JOINT". The rebar is labeled "REBAR W/1'-0\" HOOK". A note points to the joint area: "SEE PLAN".

- | | | | | | | | | |
|----------------|-------|-------|--------|-------|-------|-------|--------|-------|
| BAR SIZE: | #4 | #5 | #6 | #7 | #8 | #9 | #10 | #11 |
| SPLICE LENGTH: | 1'-3" | 1'-6" | 1'-10" | 2'-2" | 3'-8" | 4'-8" | 5'-11" | 7'-3" |

- | | | | | | | | |
|----------------|-------------|-------|--------|-------|-------|--------|--------|
| BAR SIZE: | #4 | #5 #6 | #7 | #8 | #9 | #10 | #11 |
| SPLICE LENGTH: | 1'-0" 1'-4" | 1'-7" | 1'-10" | 2'-5" | 3'-1" | 3'-11" | 4'-10" |

- ### TYPICAL TOP CORNER WALL SECTION DETAIL

Technical drawing showing the connection of a concrete headwall/wingwall to a steel banding system. The drawing includes the following dimensions and specifications:

- Concrete Headwall/Wingwall: 12" wide, 16" O.C. full length, 5/8" x 6" GALVANIZED EXPANSION ANCHOR.
- Steel Banding: 2" x 2" x 1/4" GALVANIZED STEEL BANDING BARS AROUND EDGES (TYP.).
- Connection Hardware: 3/8" BOLT @ 18" O.C., WASHER, CONTINUOUS L 4" x 3" x 3/8" GALVANIZED STEEL BRACKET (MIN. 2" BEARING SURFACE).
- Other Dimensions: 3" (width of bracket), 4" (height of bracket), 5" (height of concrete headwall/wingwall).

SLOT

GRATE

WASHER

OFFSET

5/8"x8" BOLT

INLET WALL

SLOT DETAIL

1-1/2"

3/4"

3/8" R.

3" x 1/4" FLAT

1-1/16" x 1" SLOTTED HOLE

3/16" THICK

1-3/4"

1-1/2"

1-1/4"

3" x 1/4"

ALTERNATE SLOT AND

N.T.S

N.T.S.

NTS

N.T.S

SCALE: 1/2"=1'

SCALE: 1/2"=1'

SCALE: 1/2"=1'

D	D	D	CL
			(3)

SCALE: 1/2"=1'



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BY	DATE
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REVISION

DOWN

H-SCALE

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1111

SHEET 8 OF 15

JOB NO. 16113.00









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A Westrian Company

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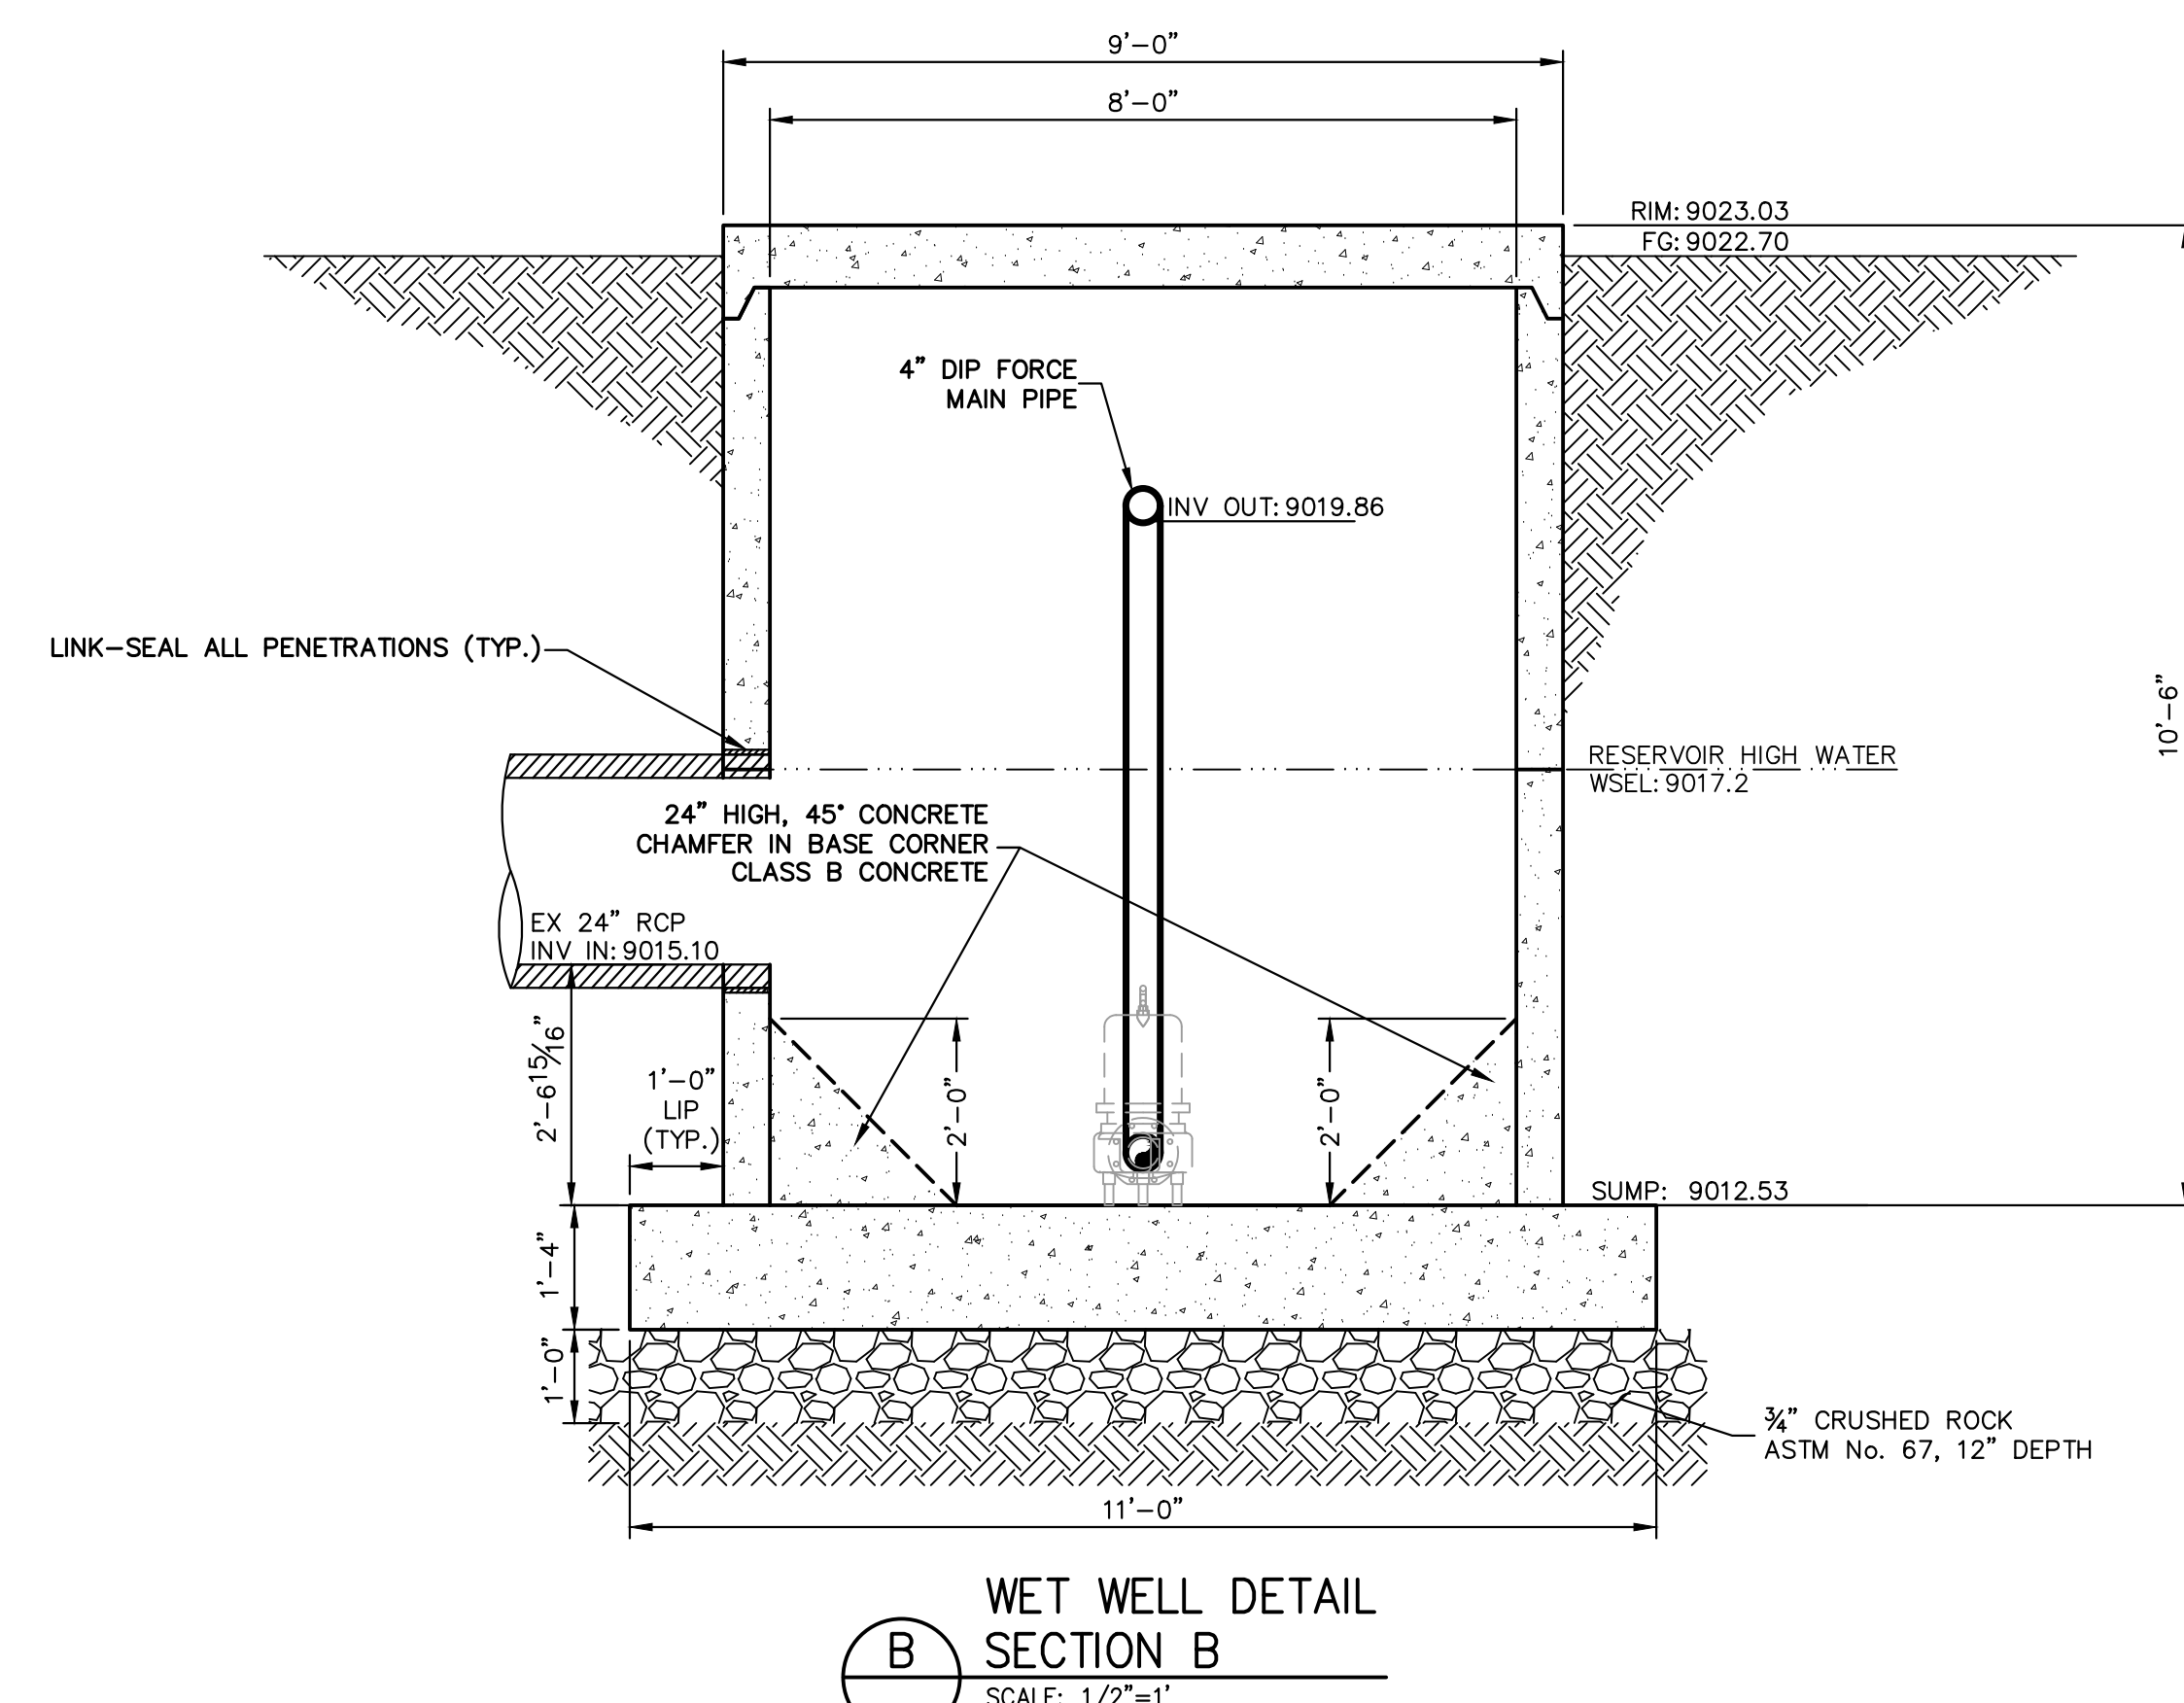
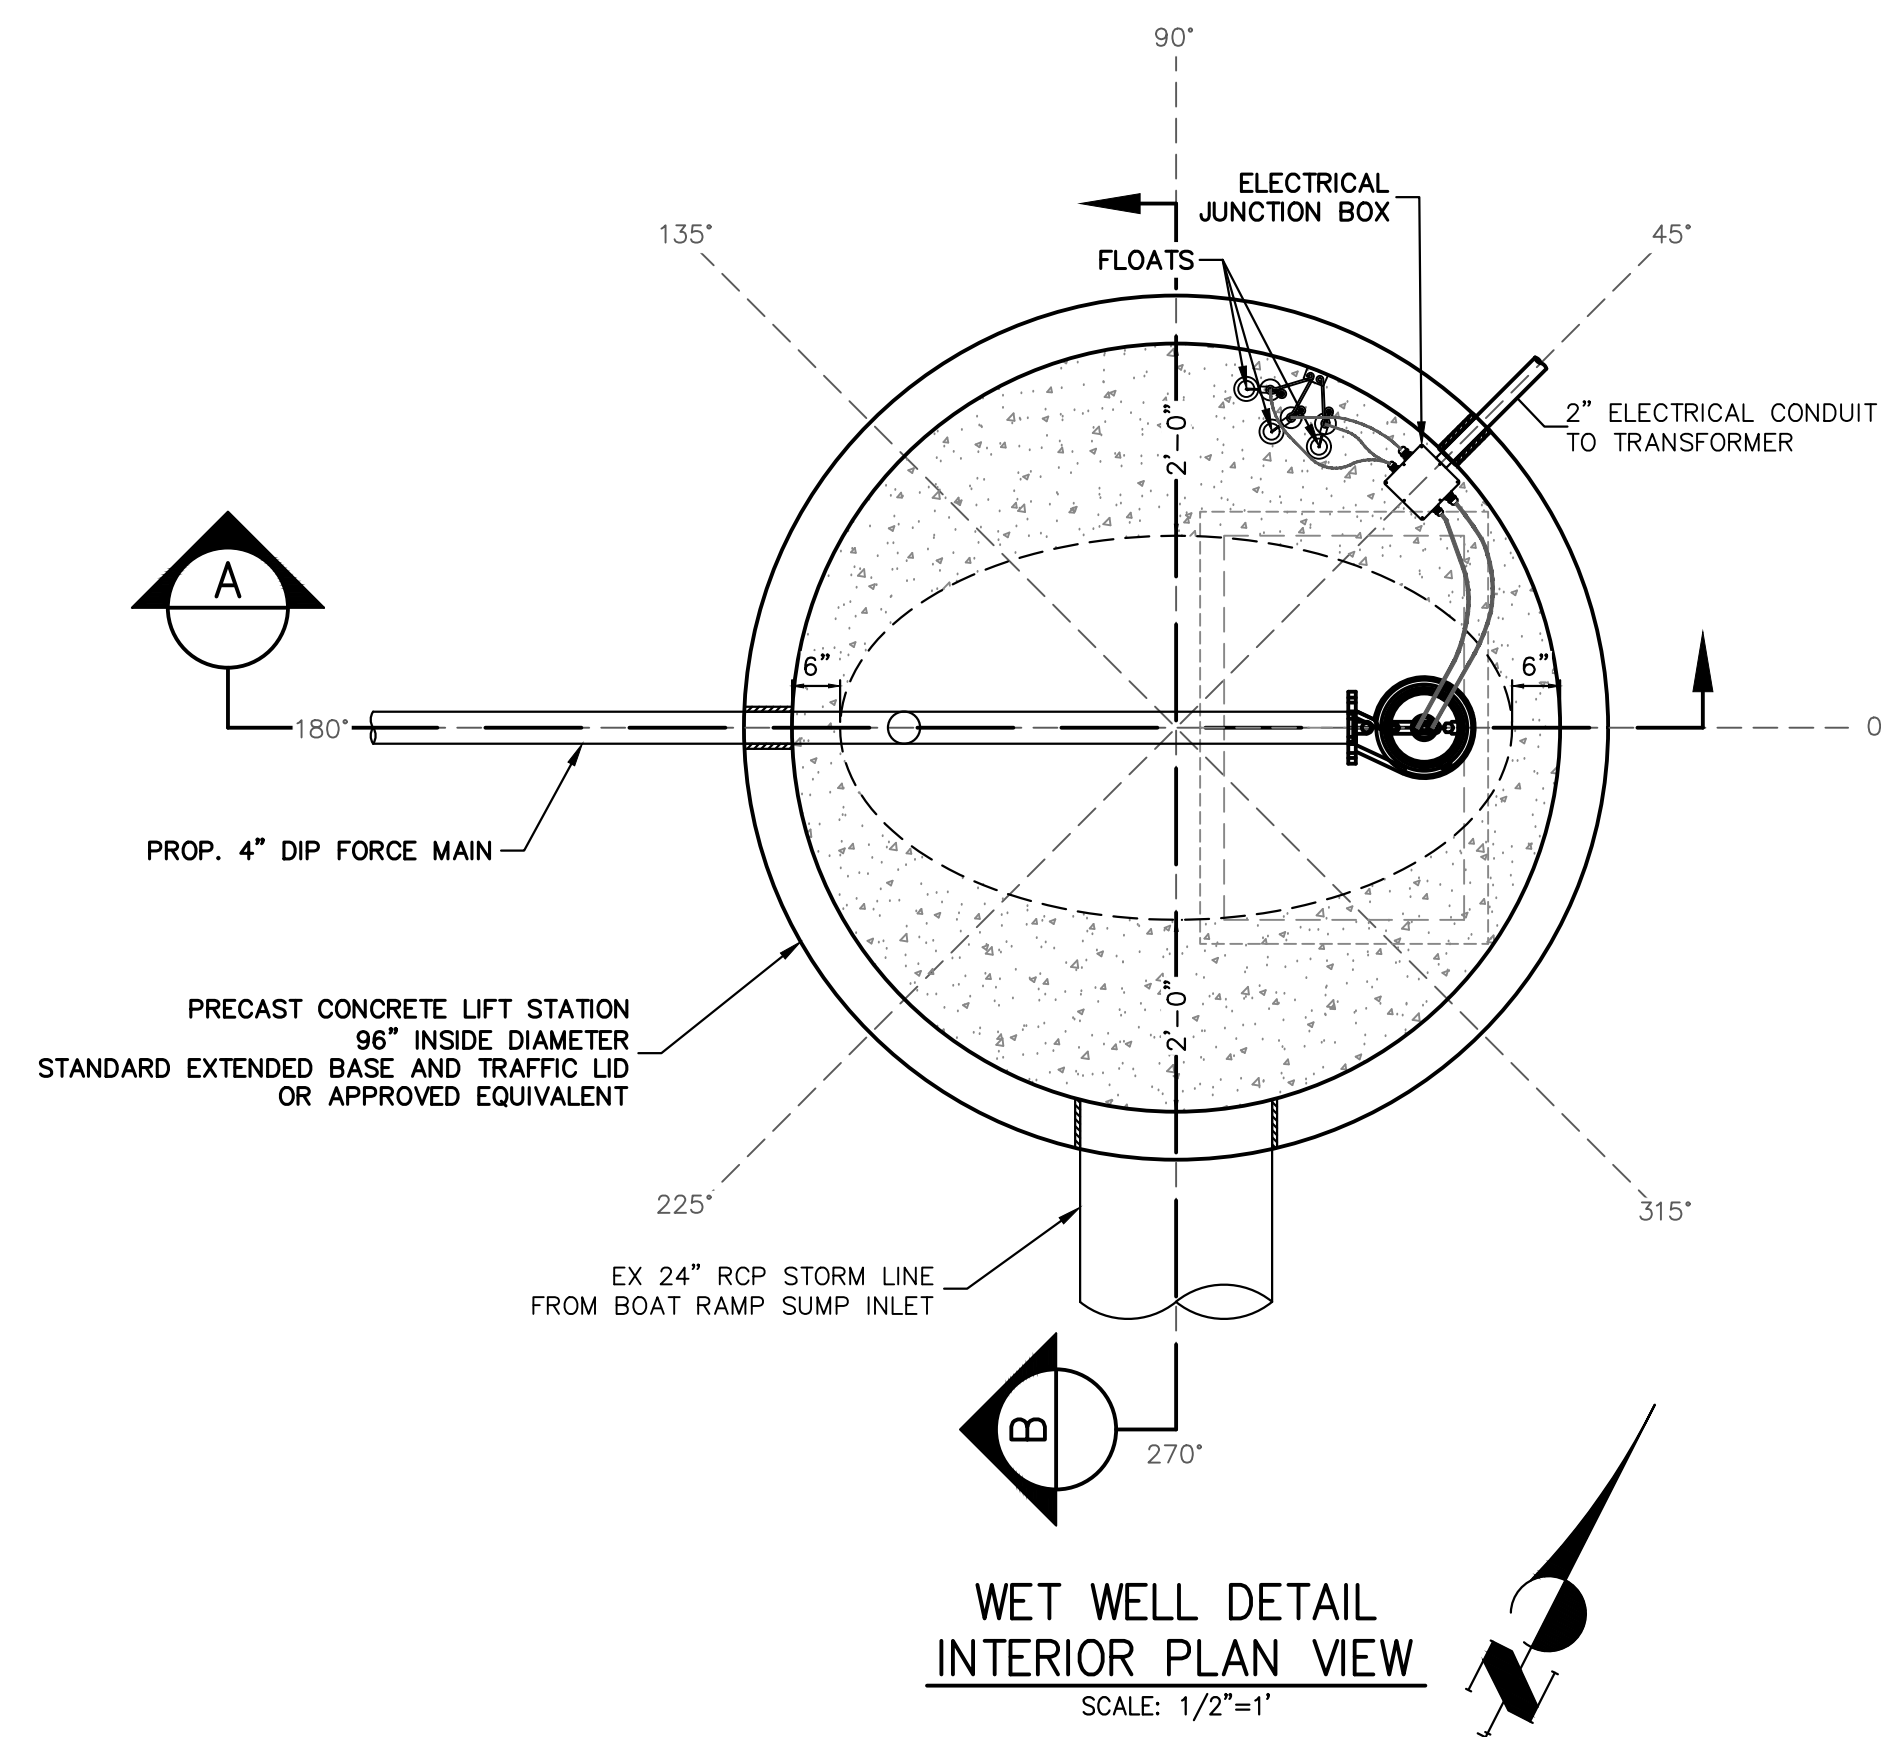
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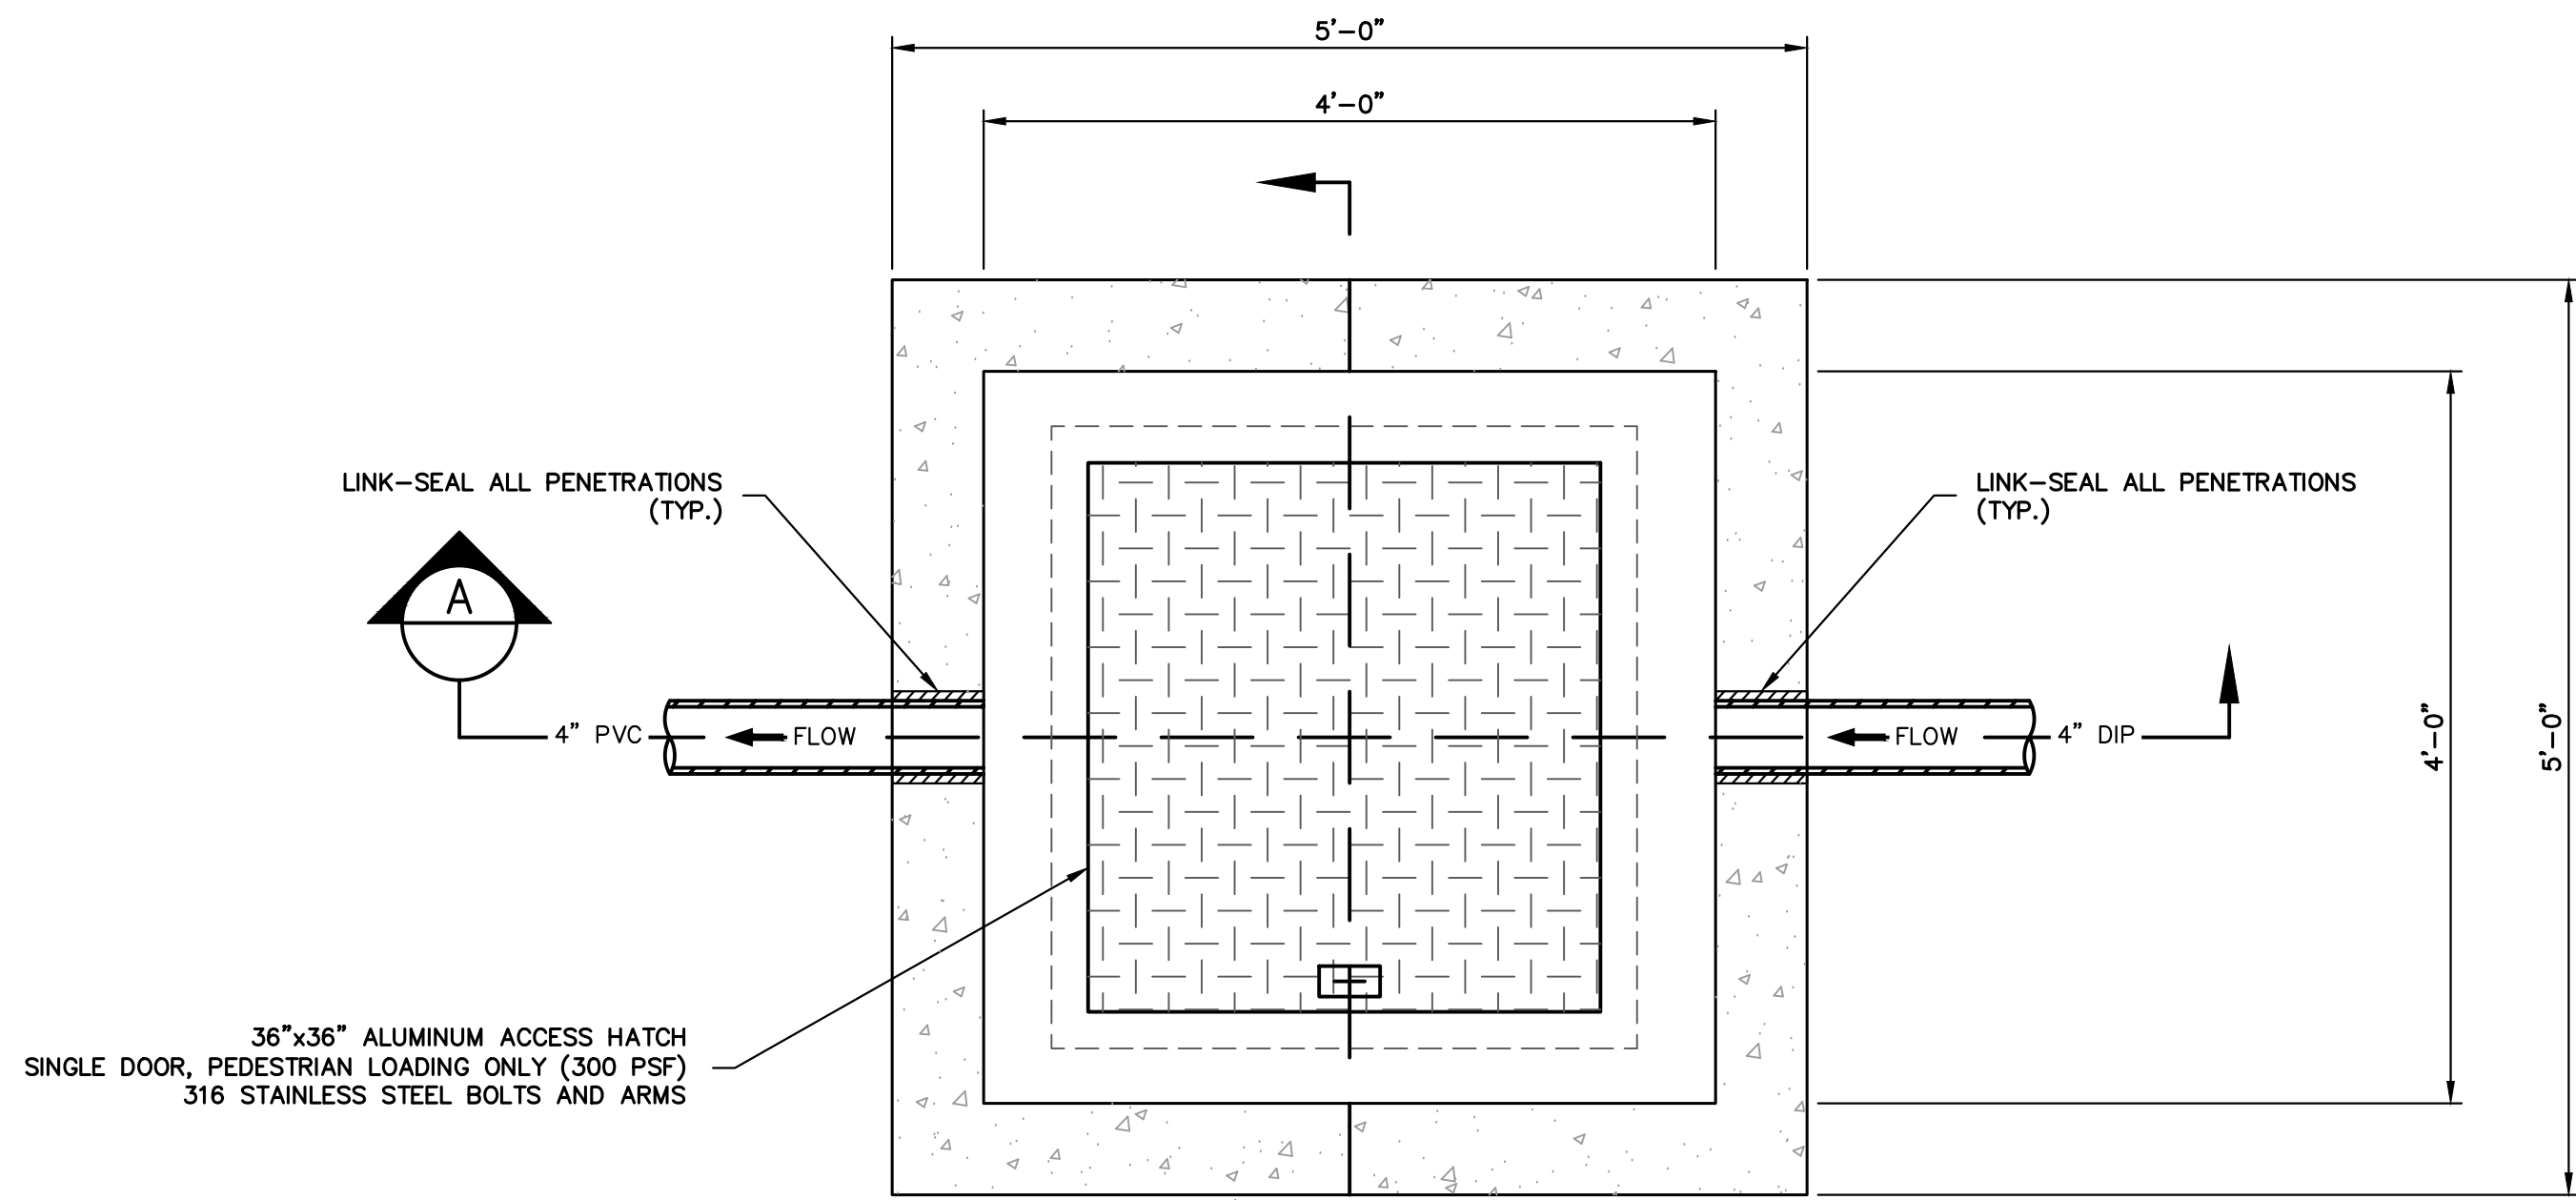
FRISCO BAY MARINA STORM DRAINAGE IMPROVEMENTS	FOREBAY DETAILS	SHEET 9 OF 15	JOB NO. 16113.00
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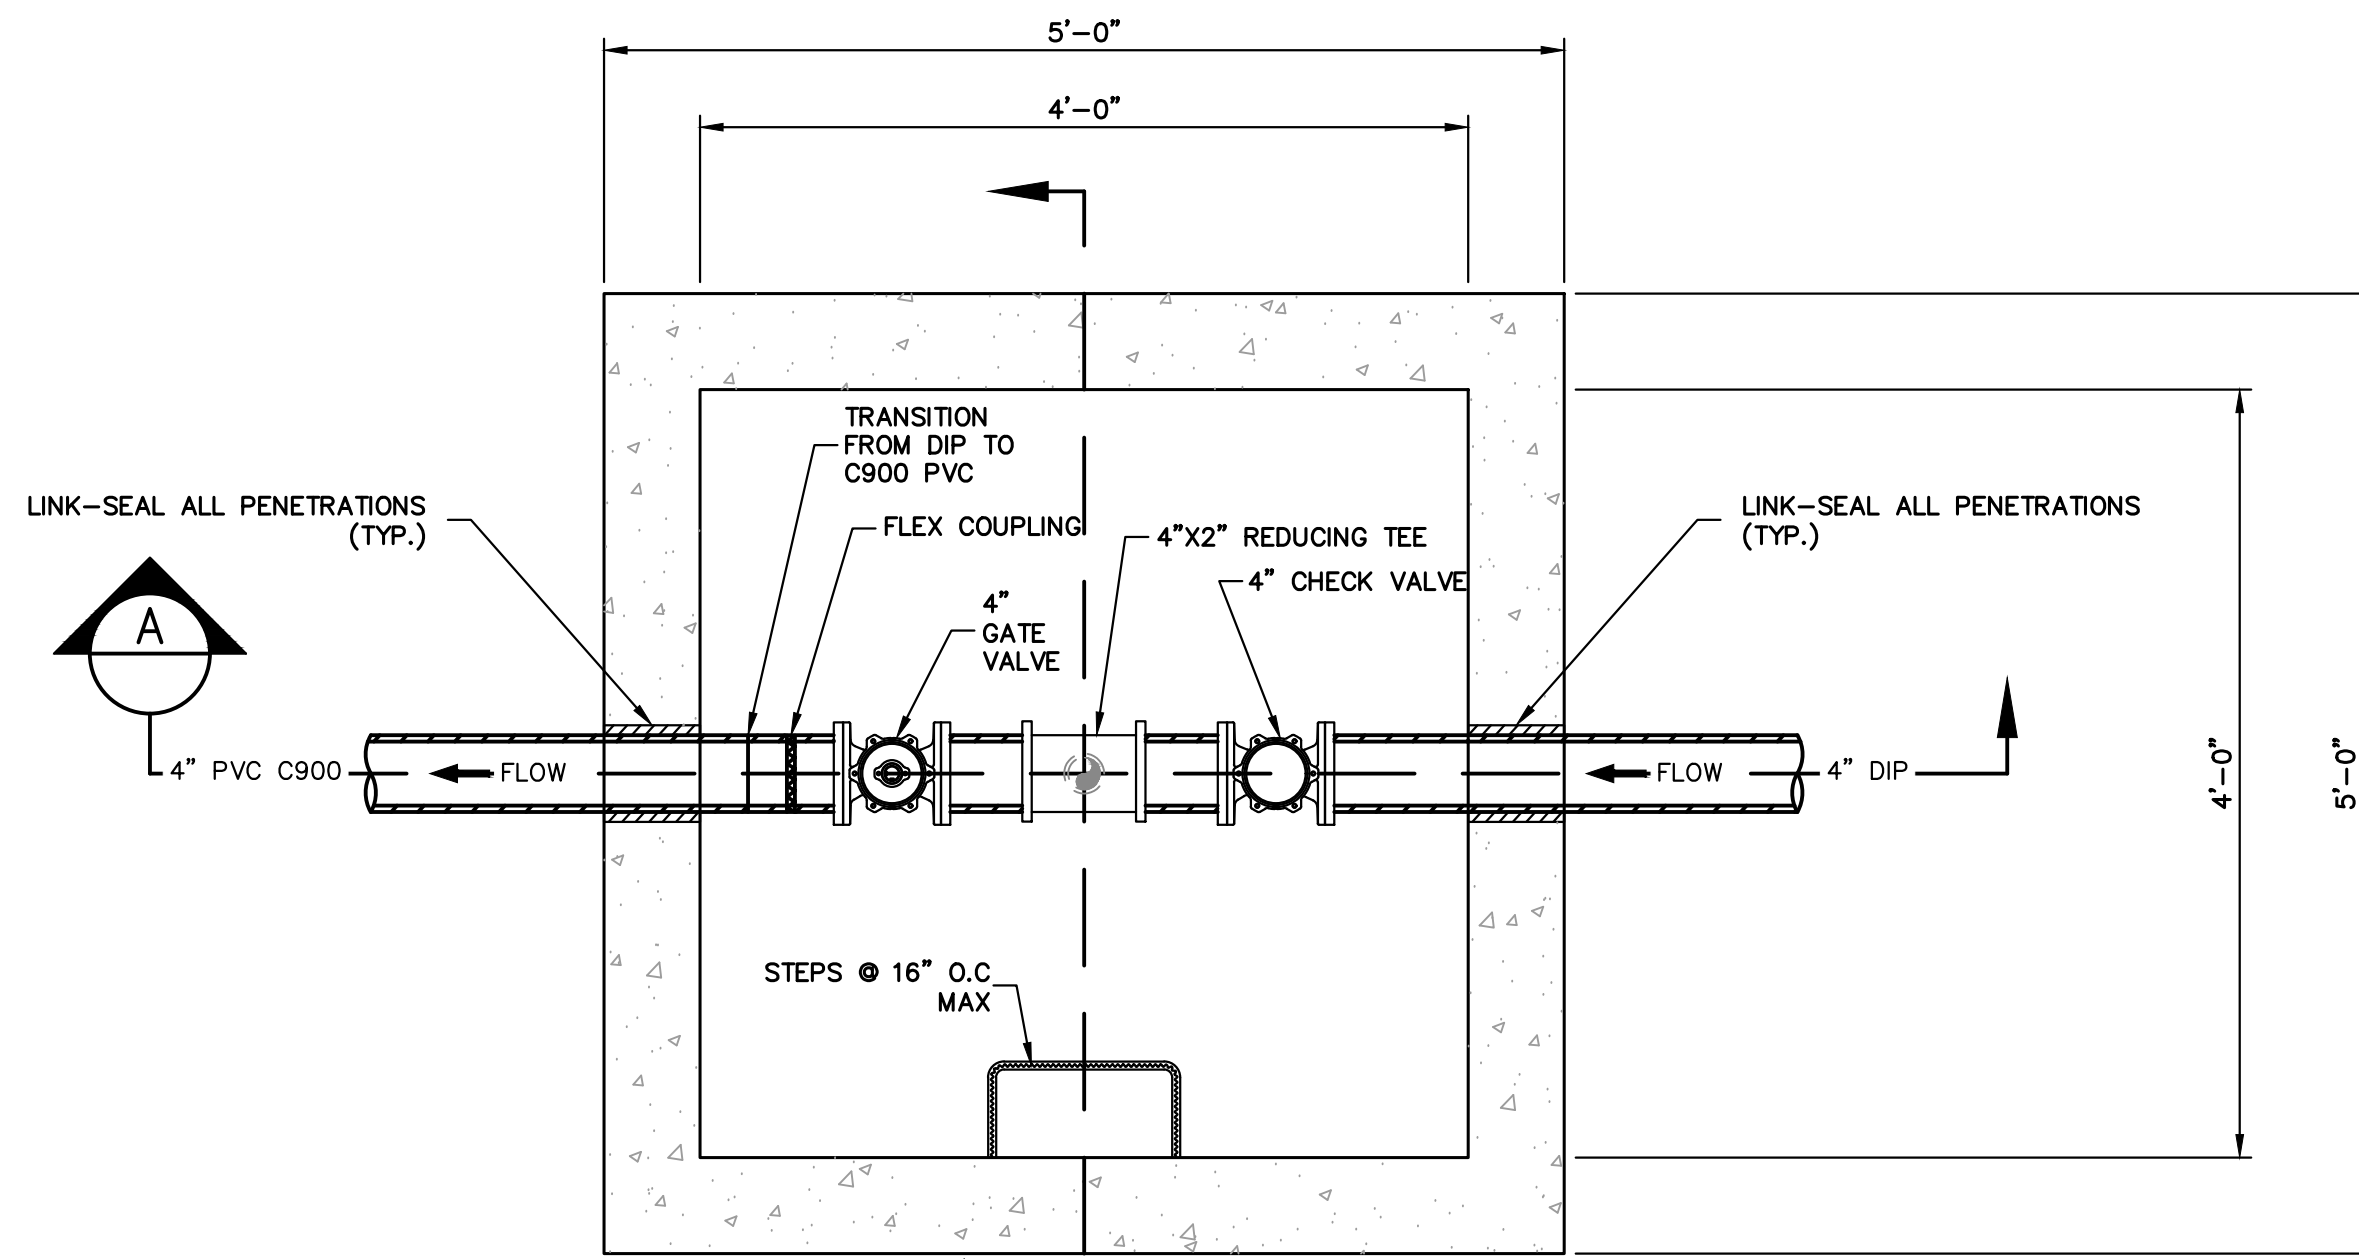
SHEET 10 OF 15

JOB NO. 16113.00


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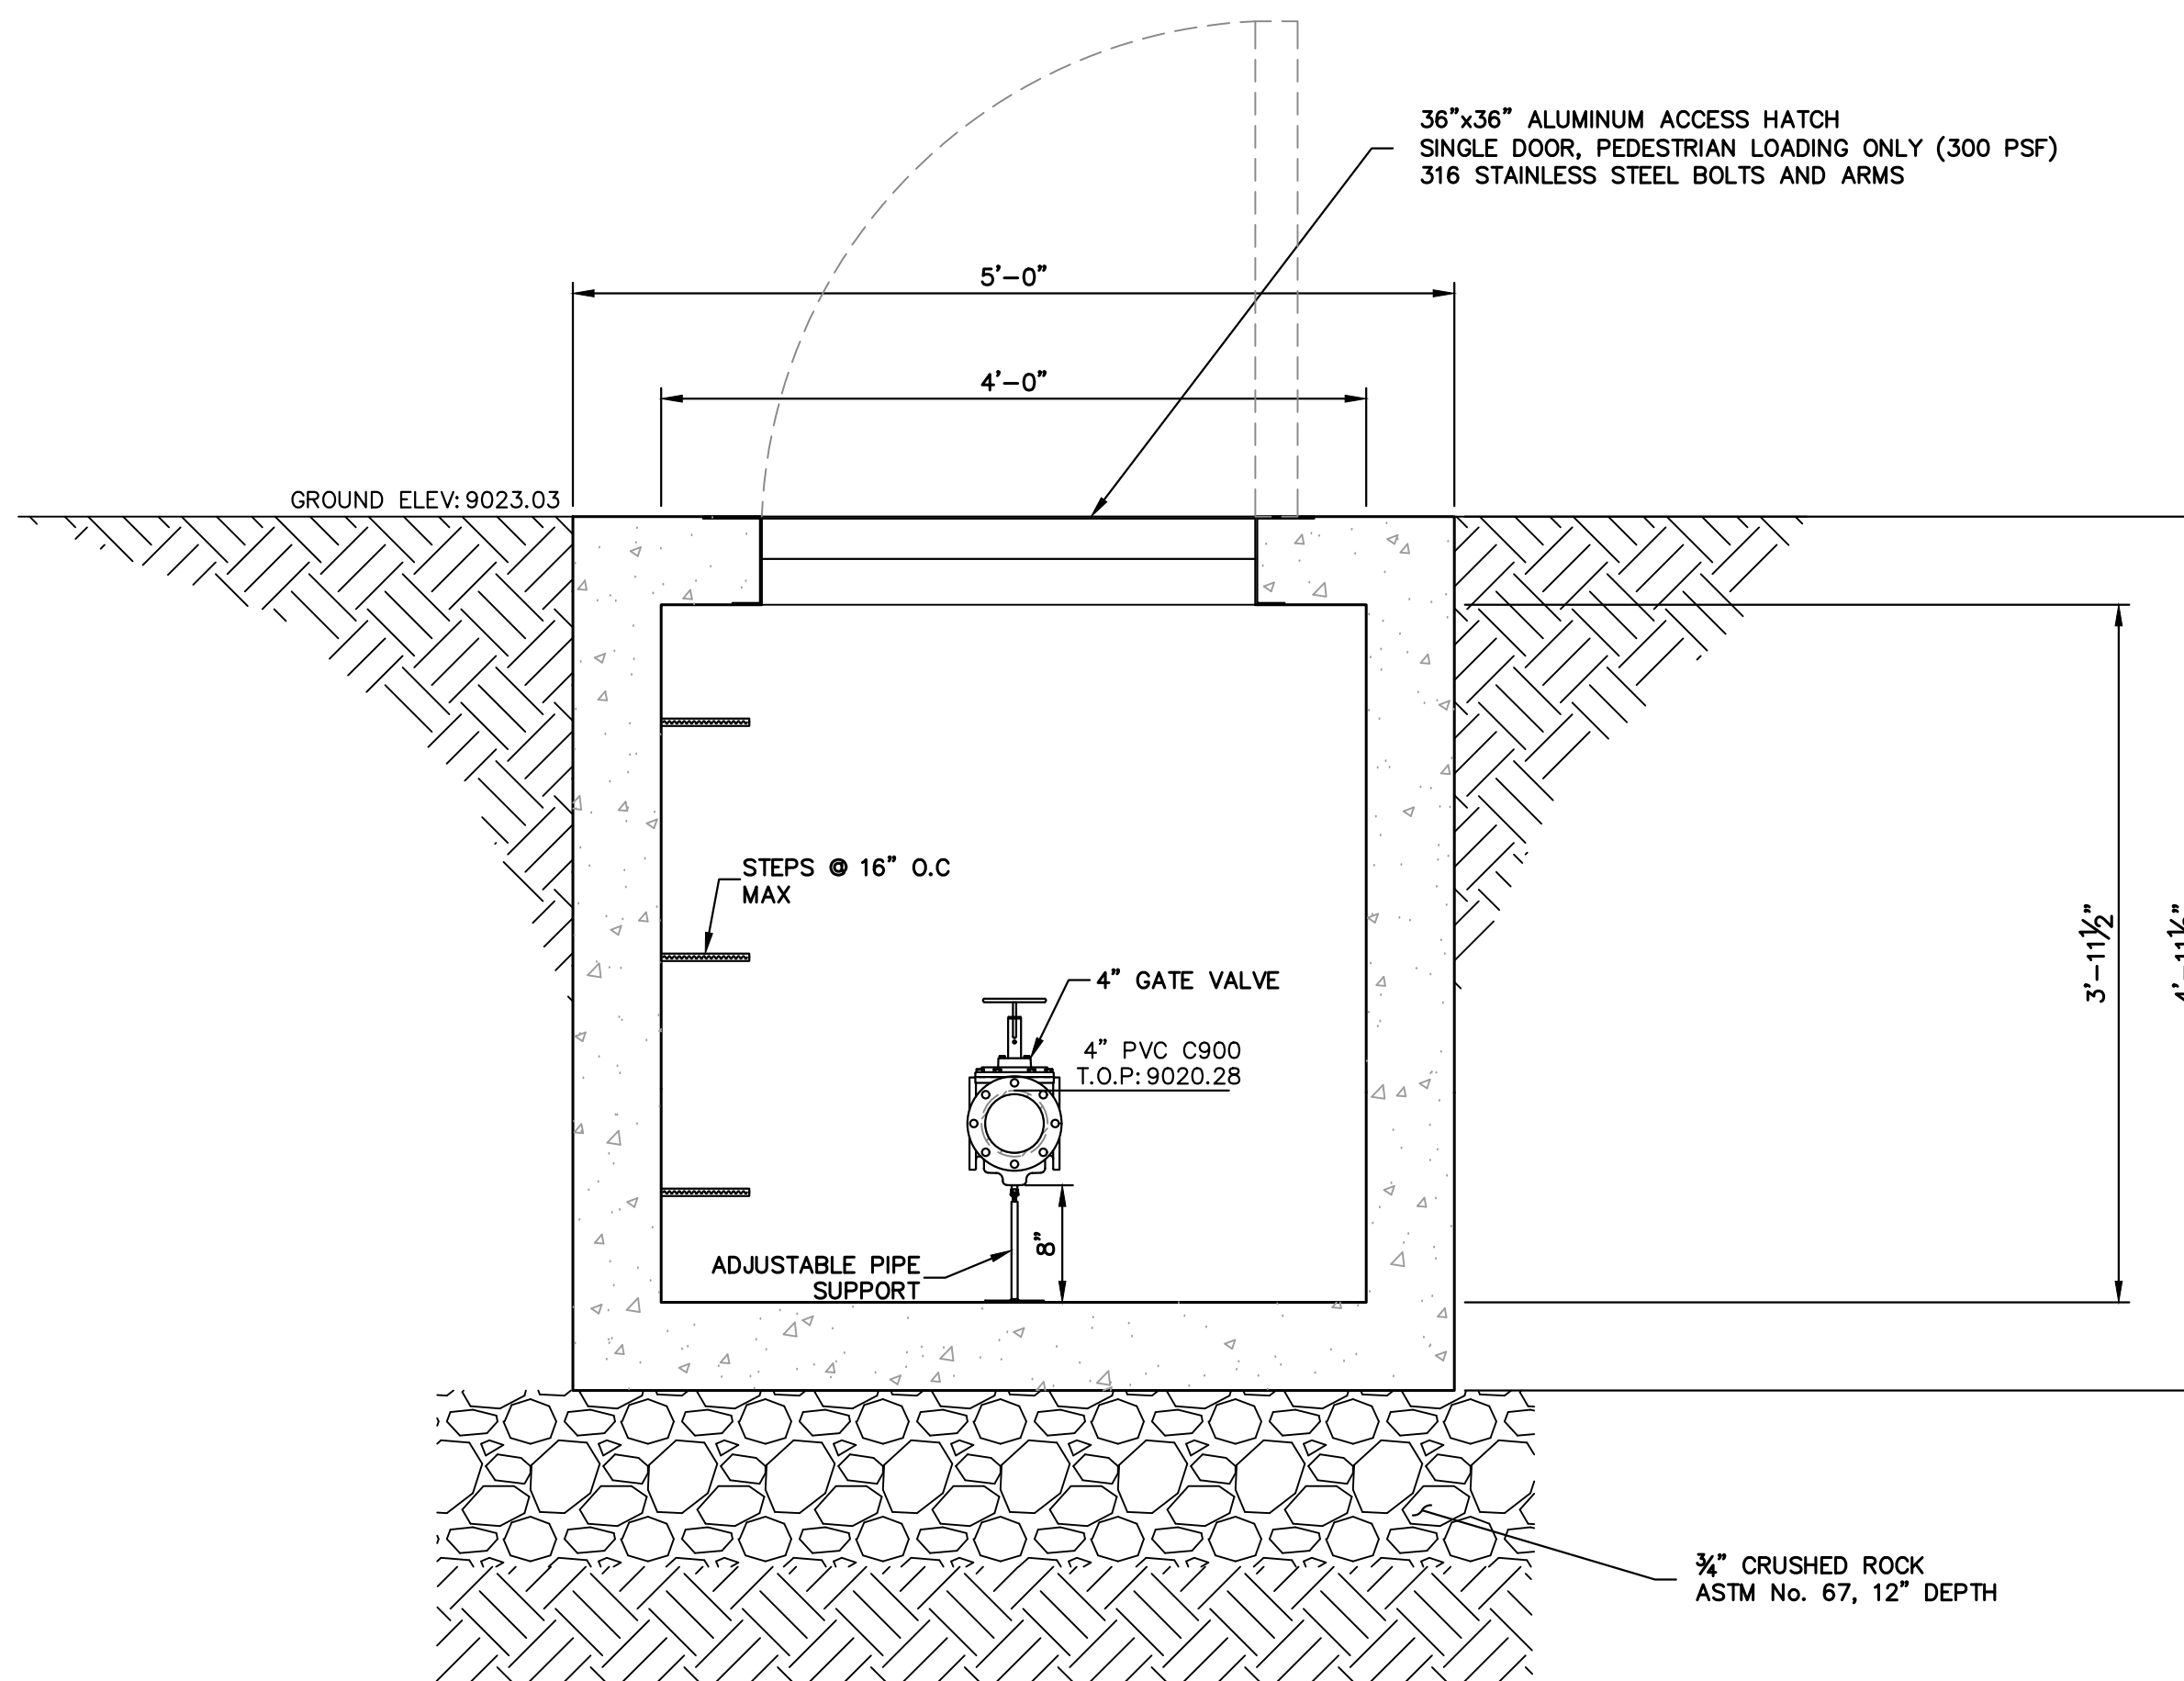
UTILITY VAULT DETAIL
PLAN VIEW
SCALE: 1"=1'

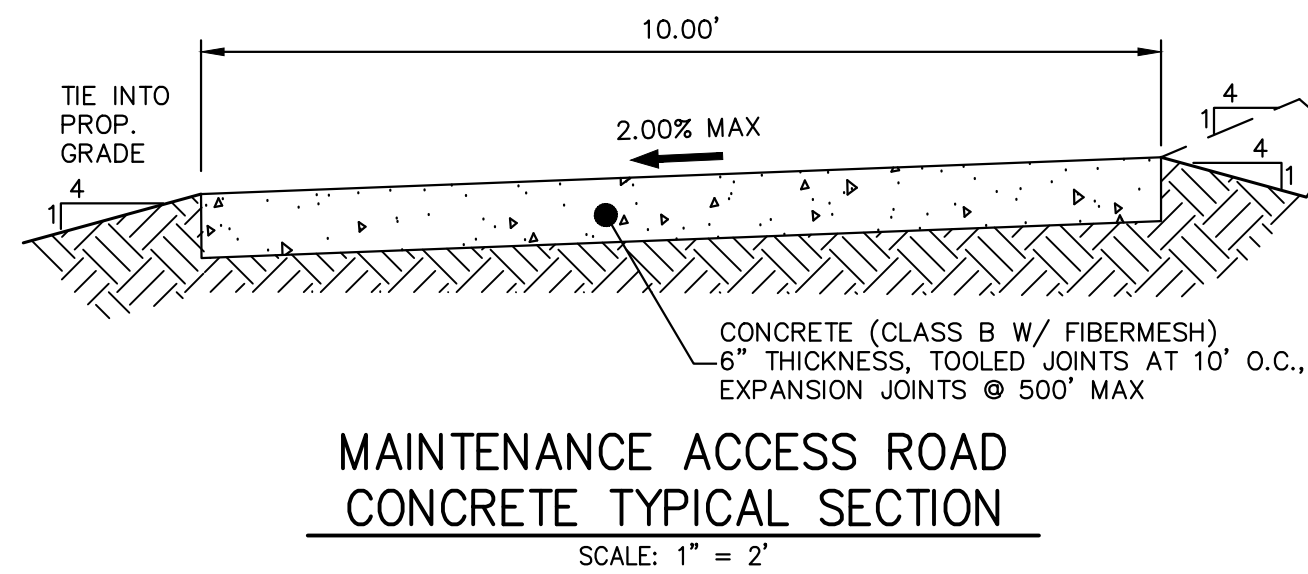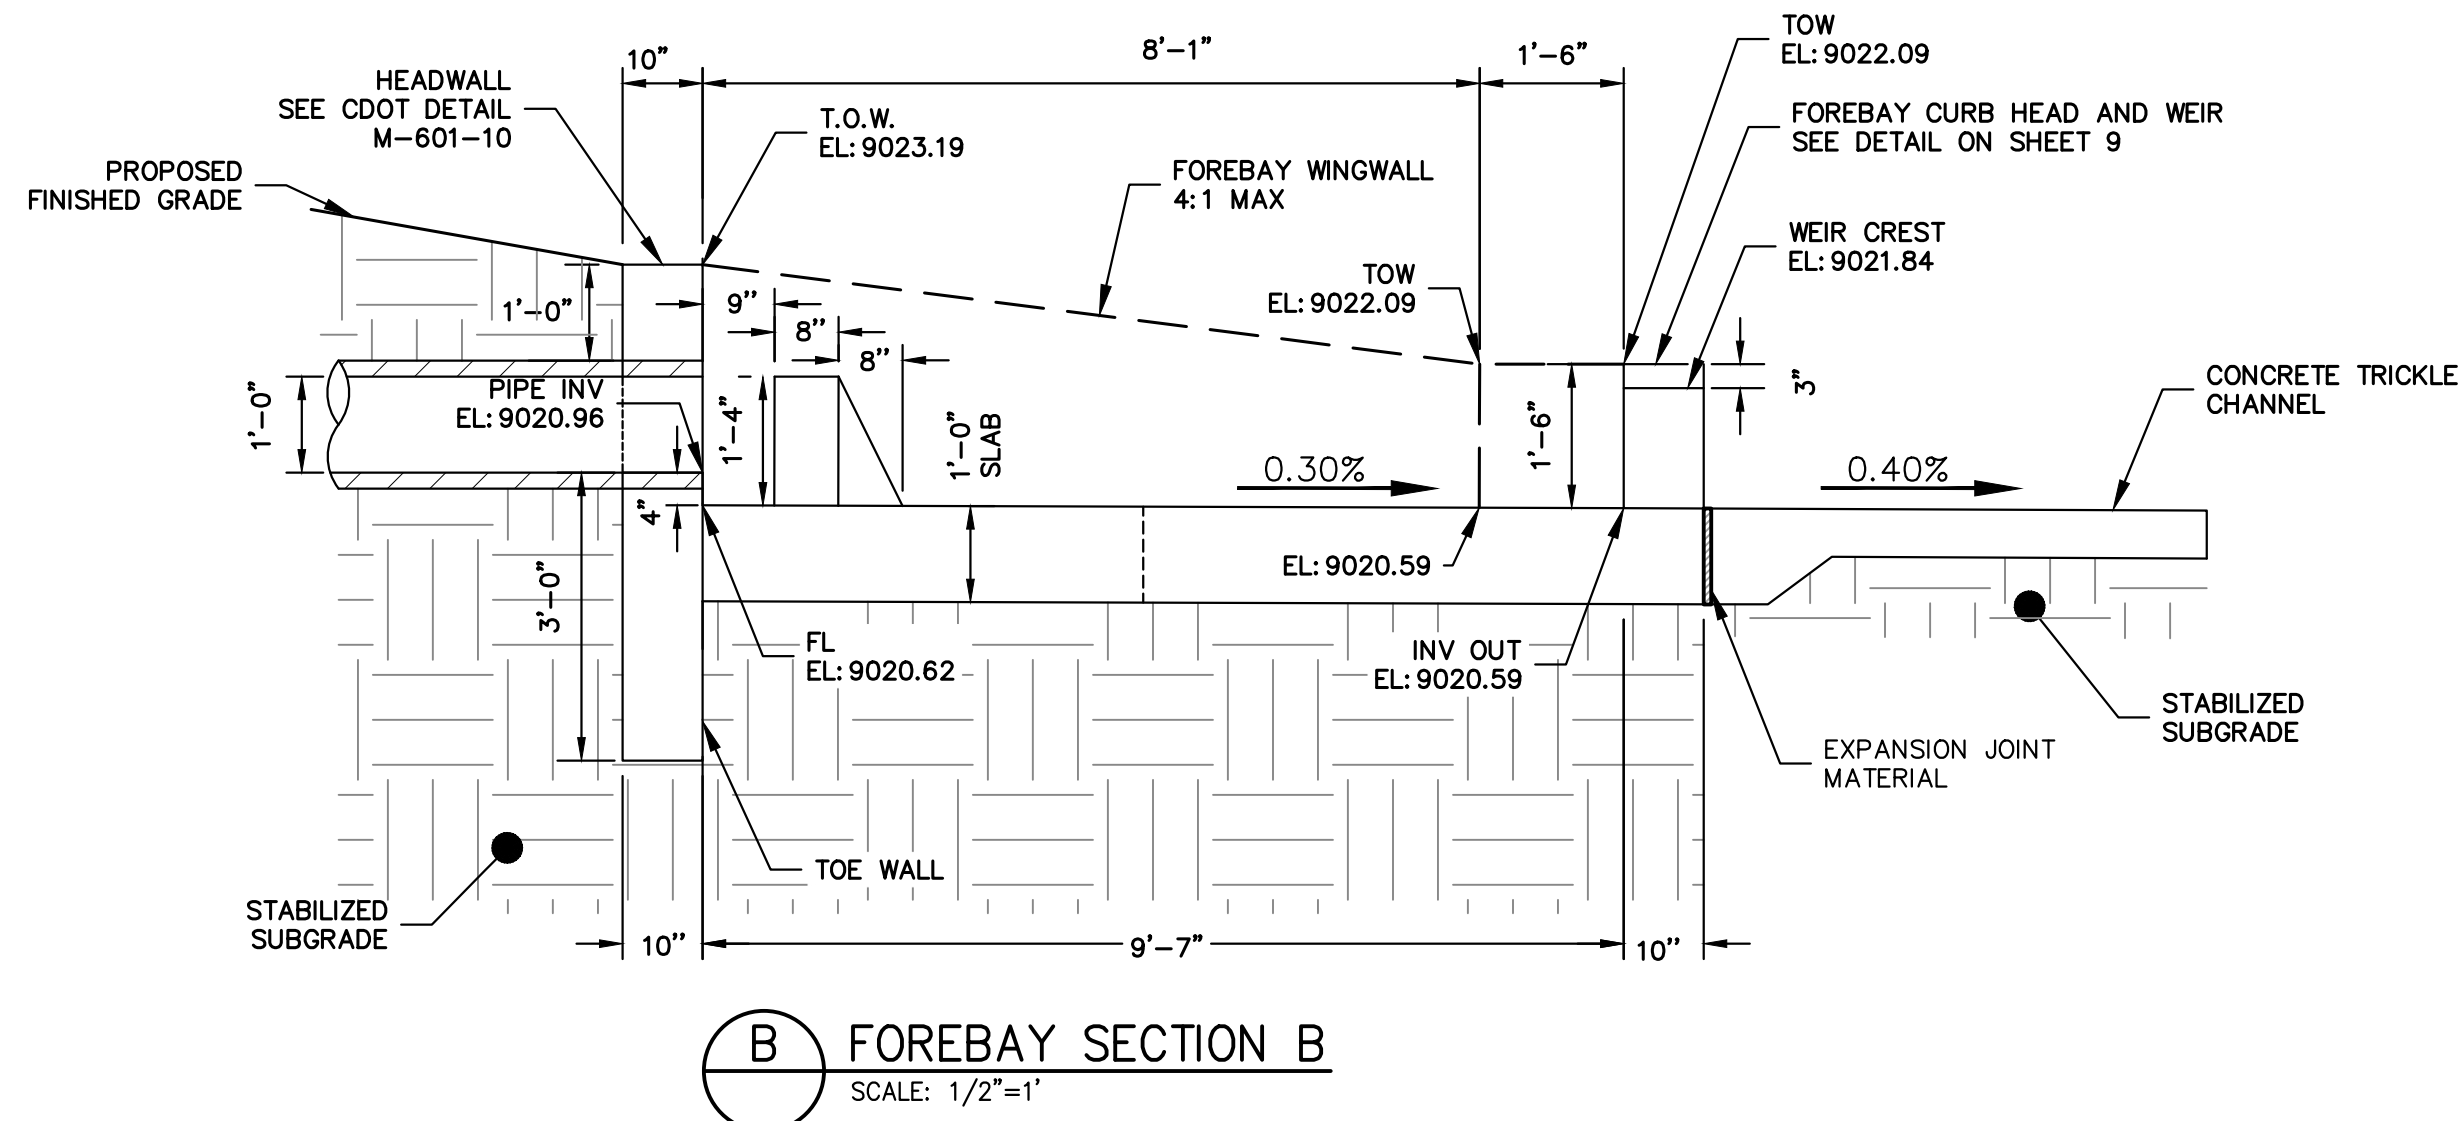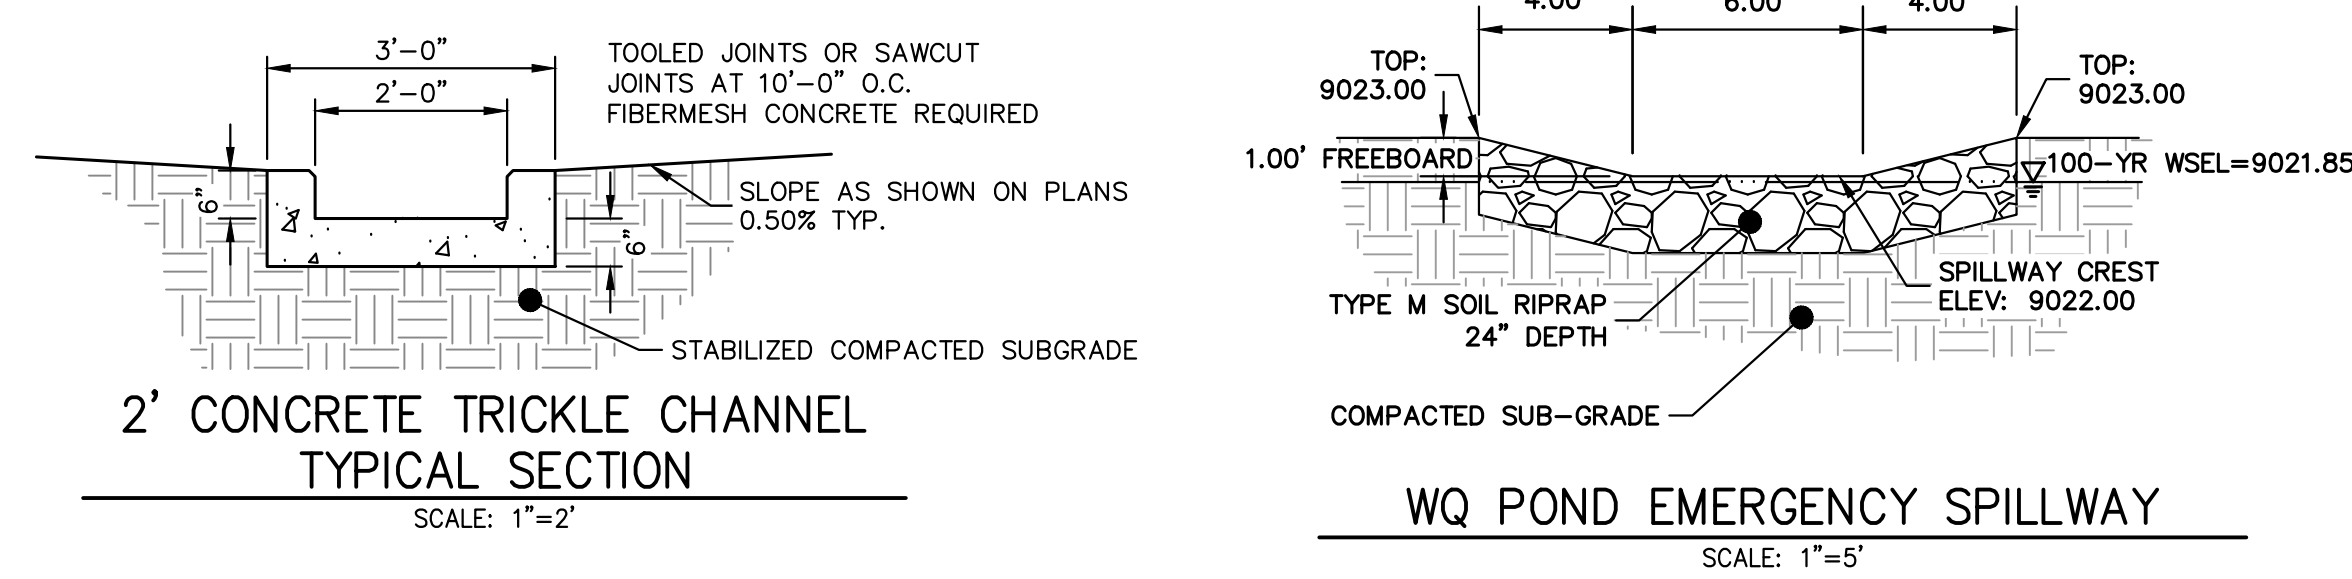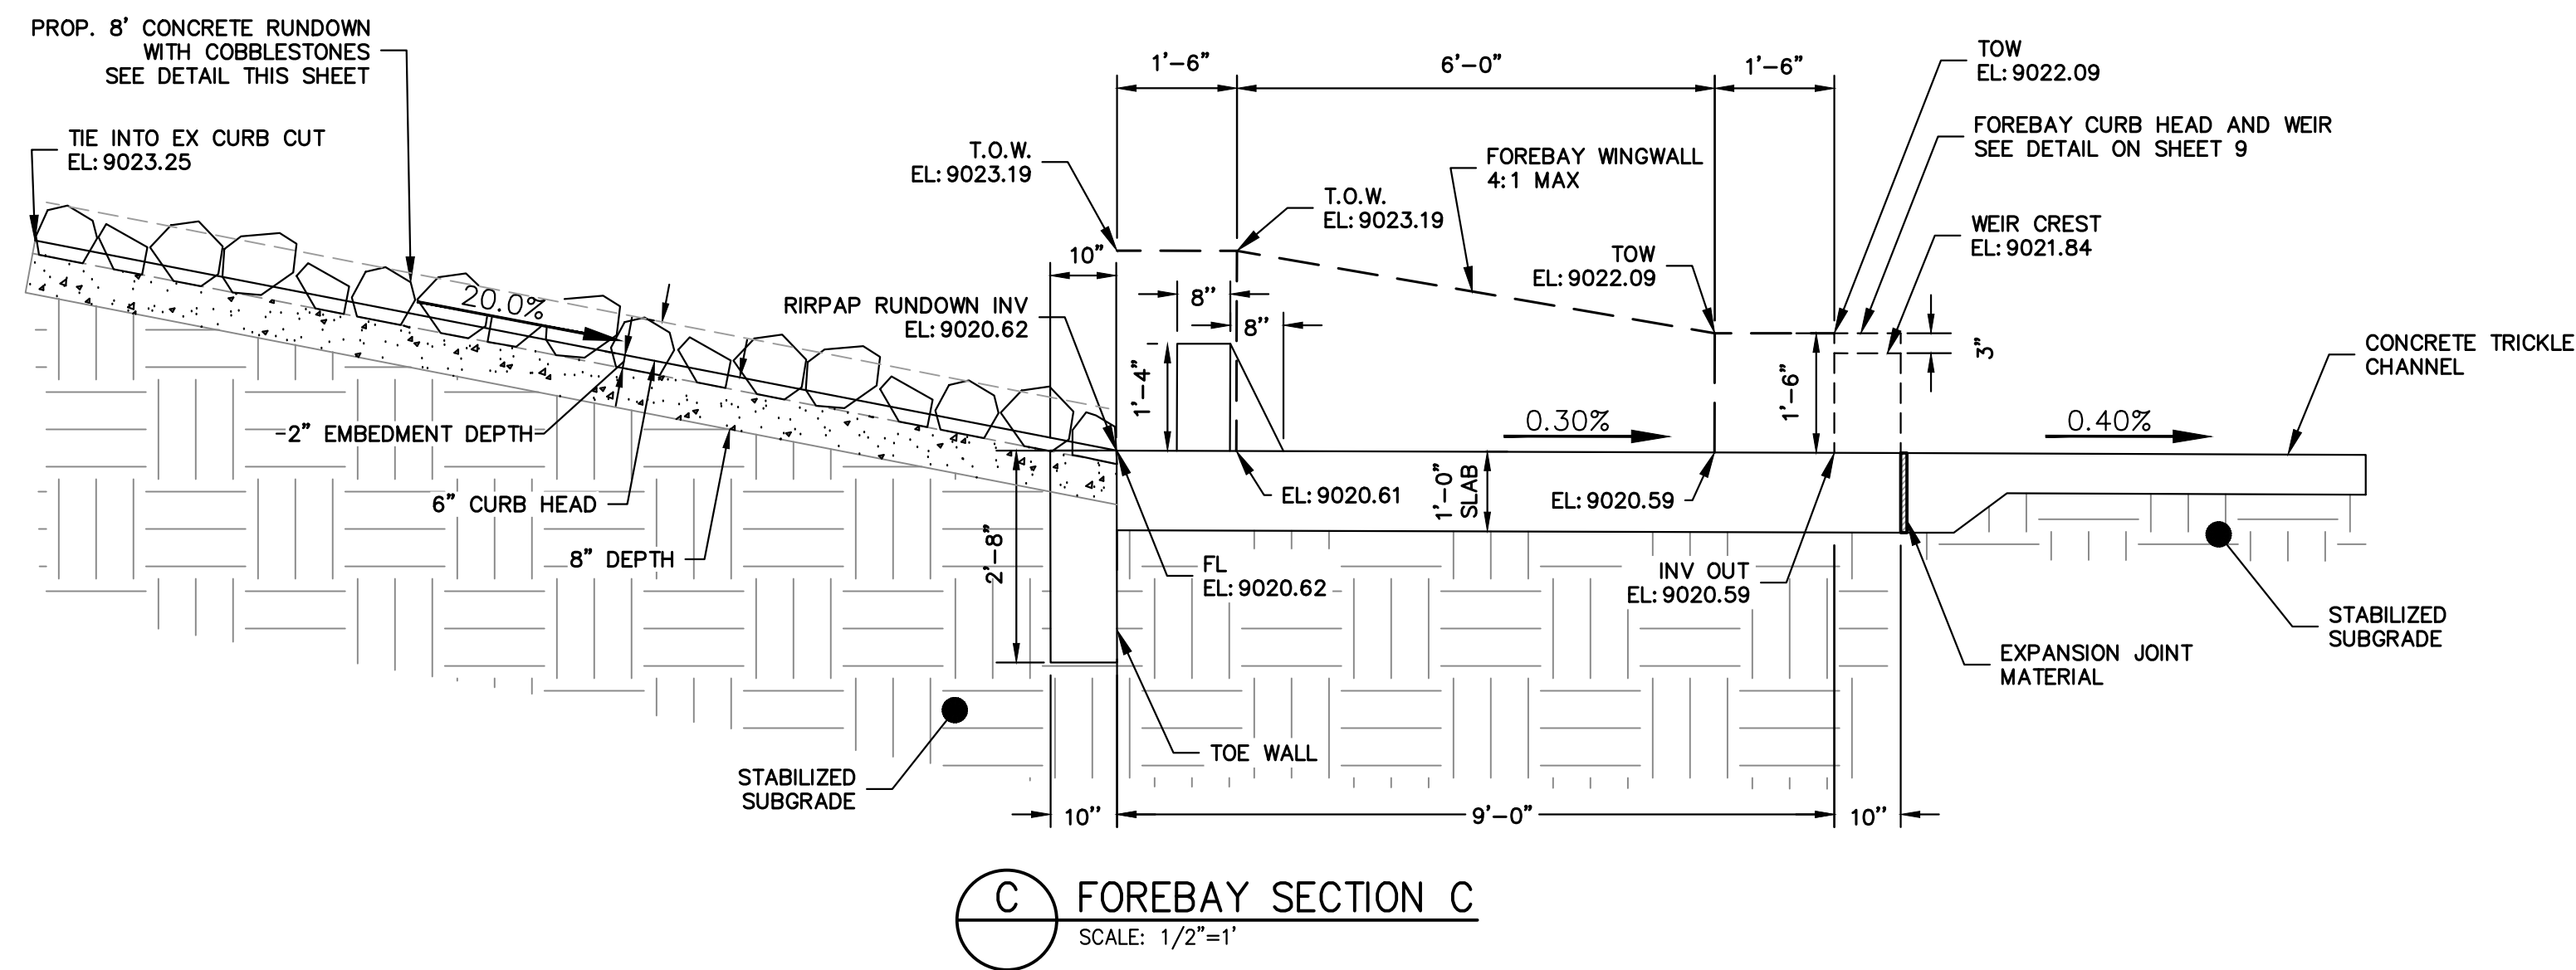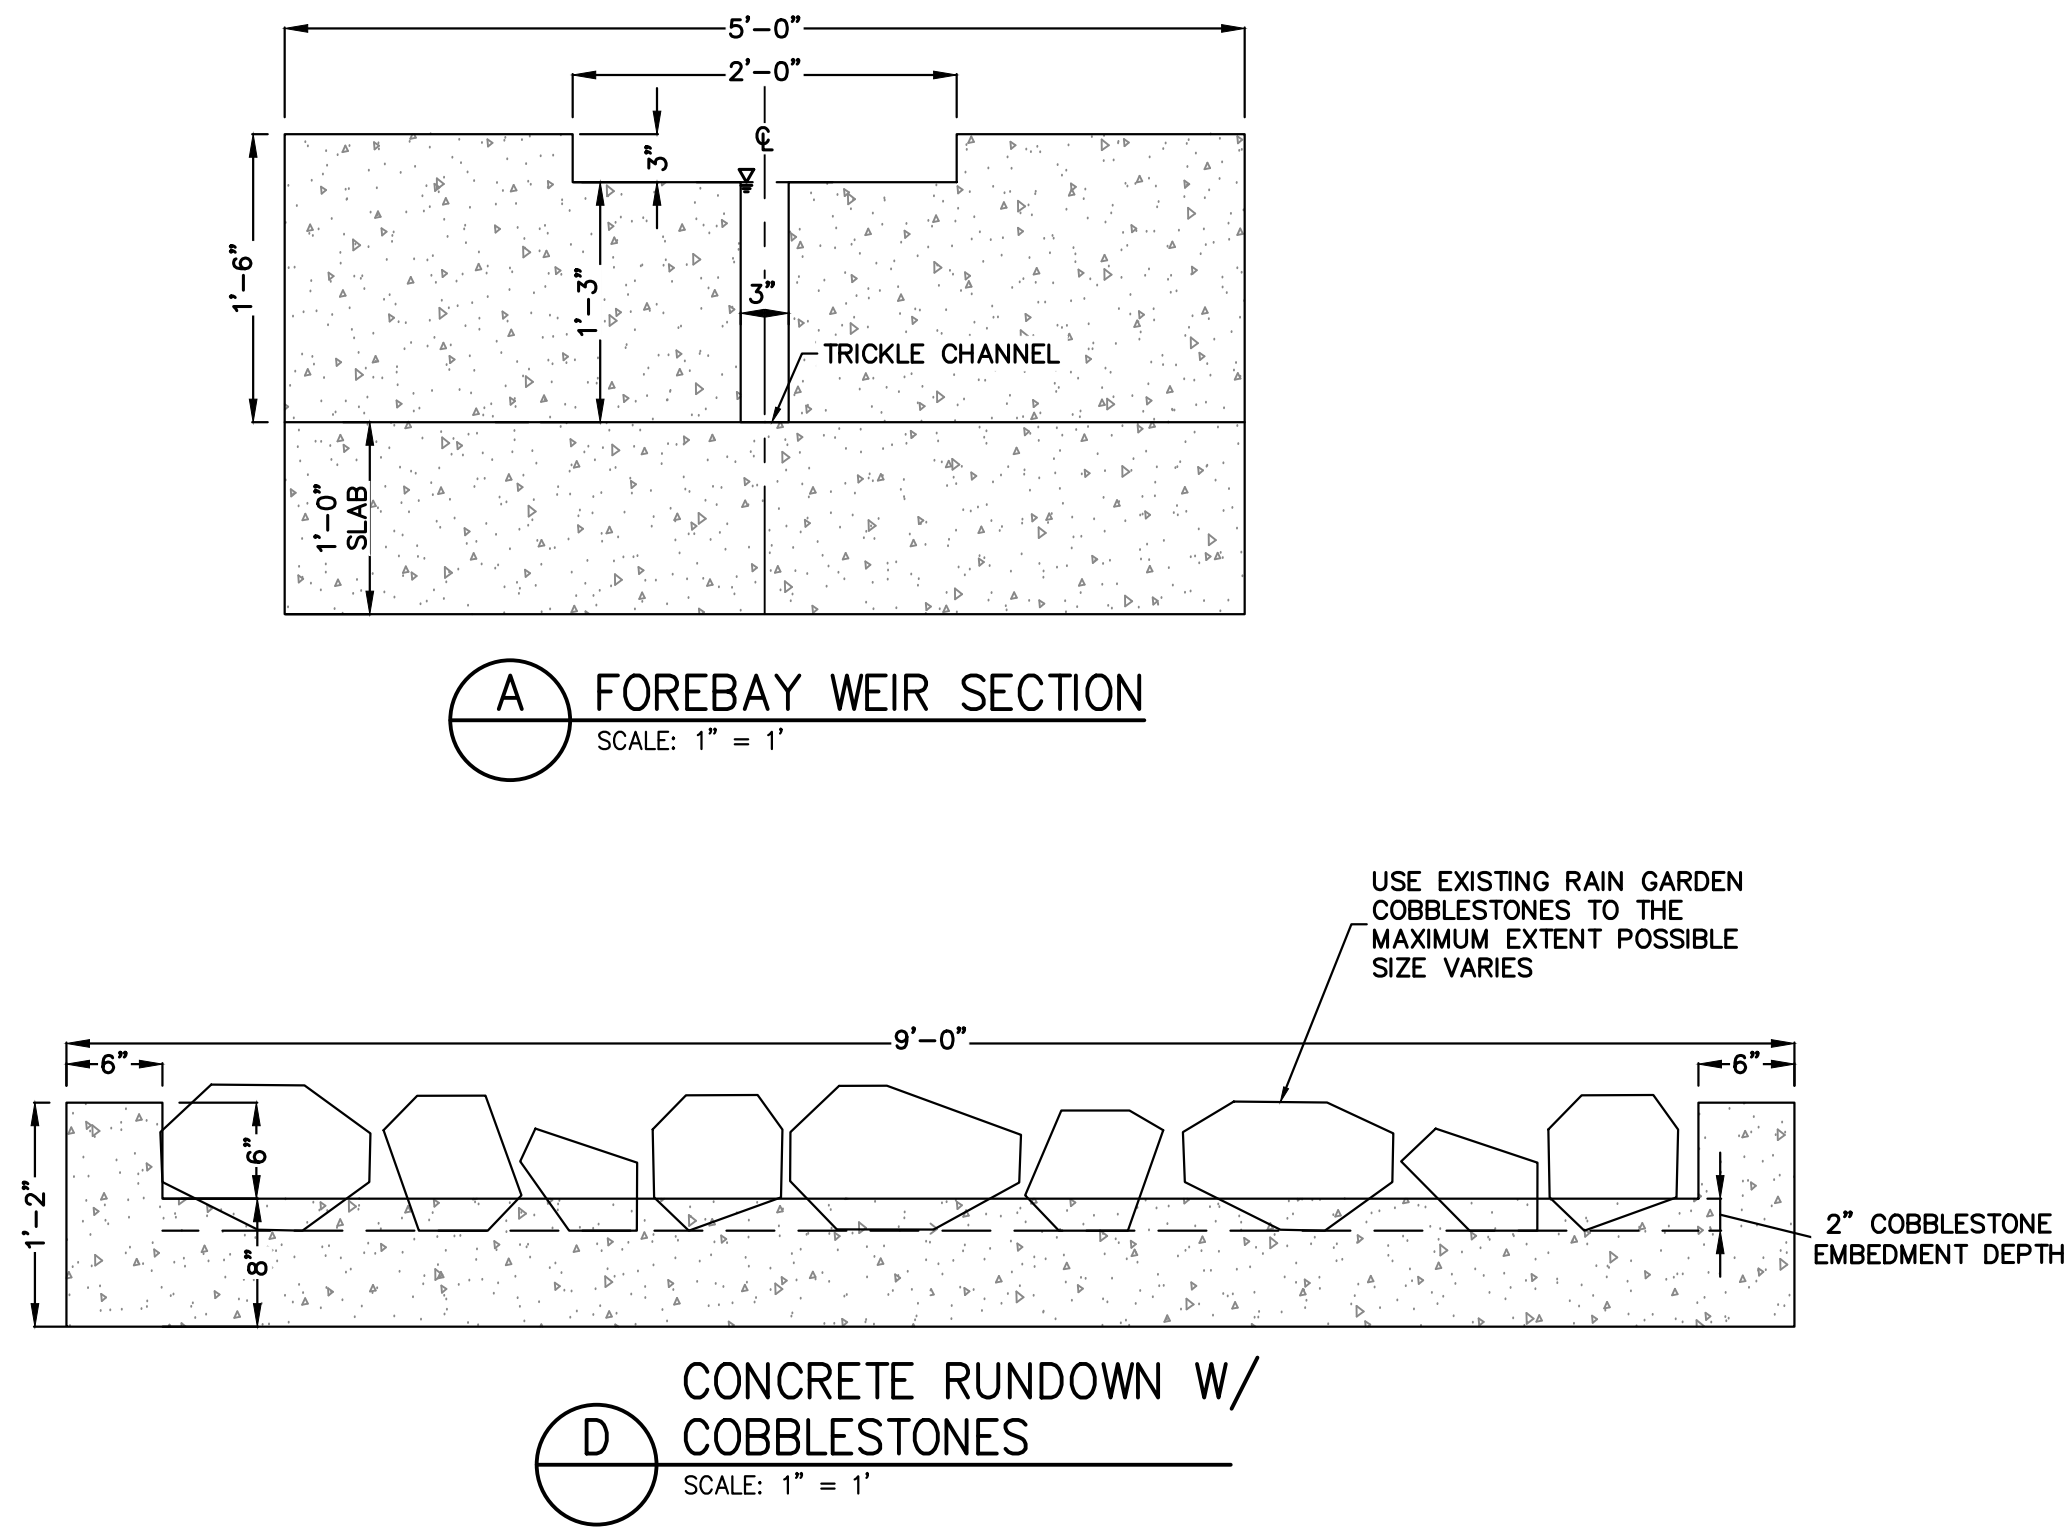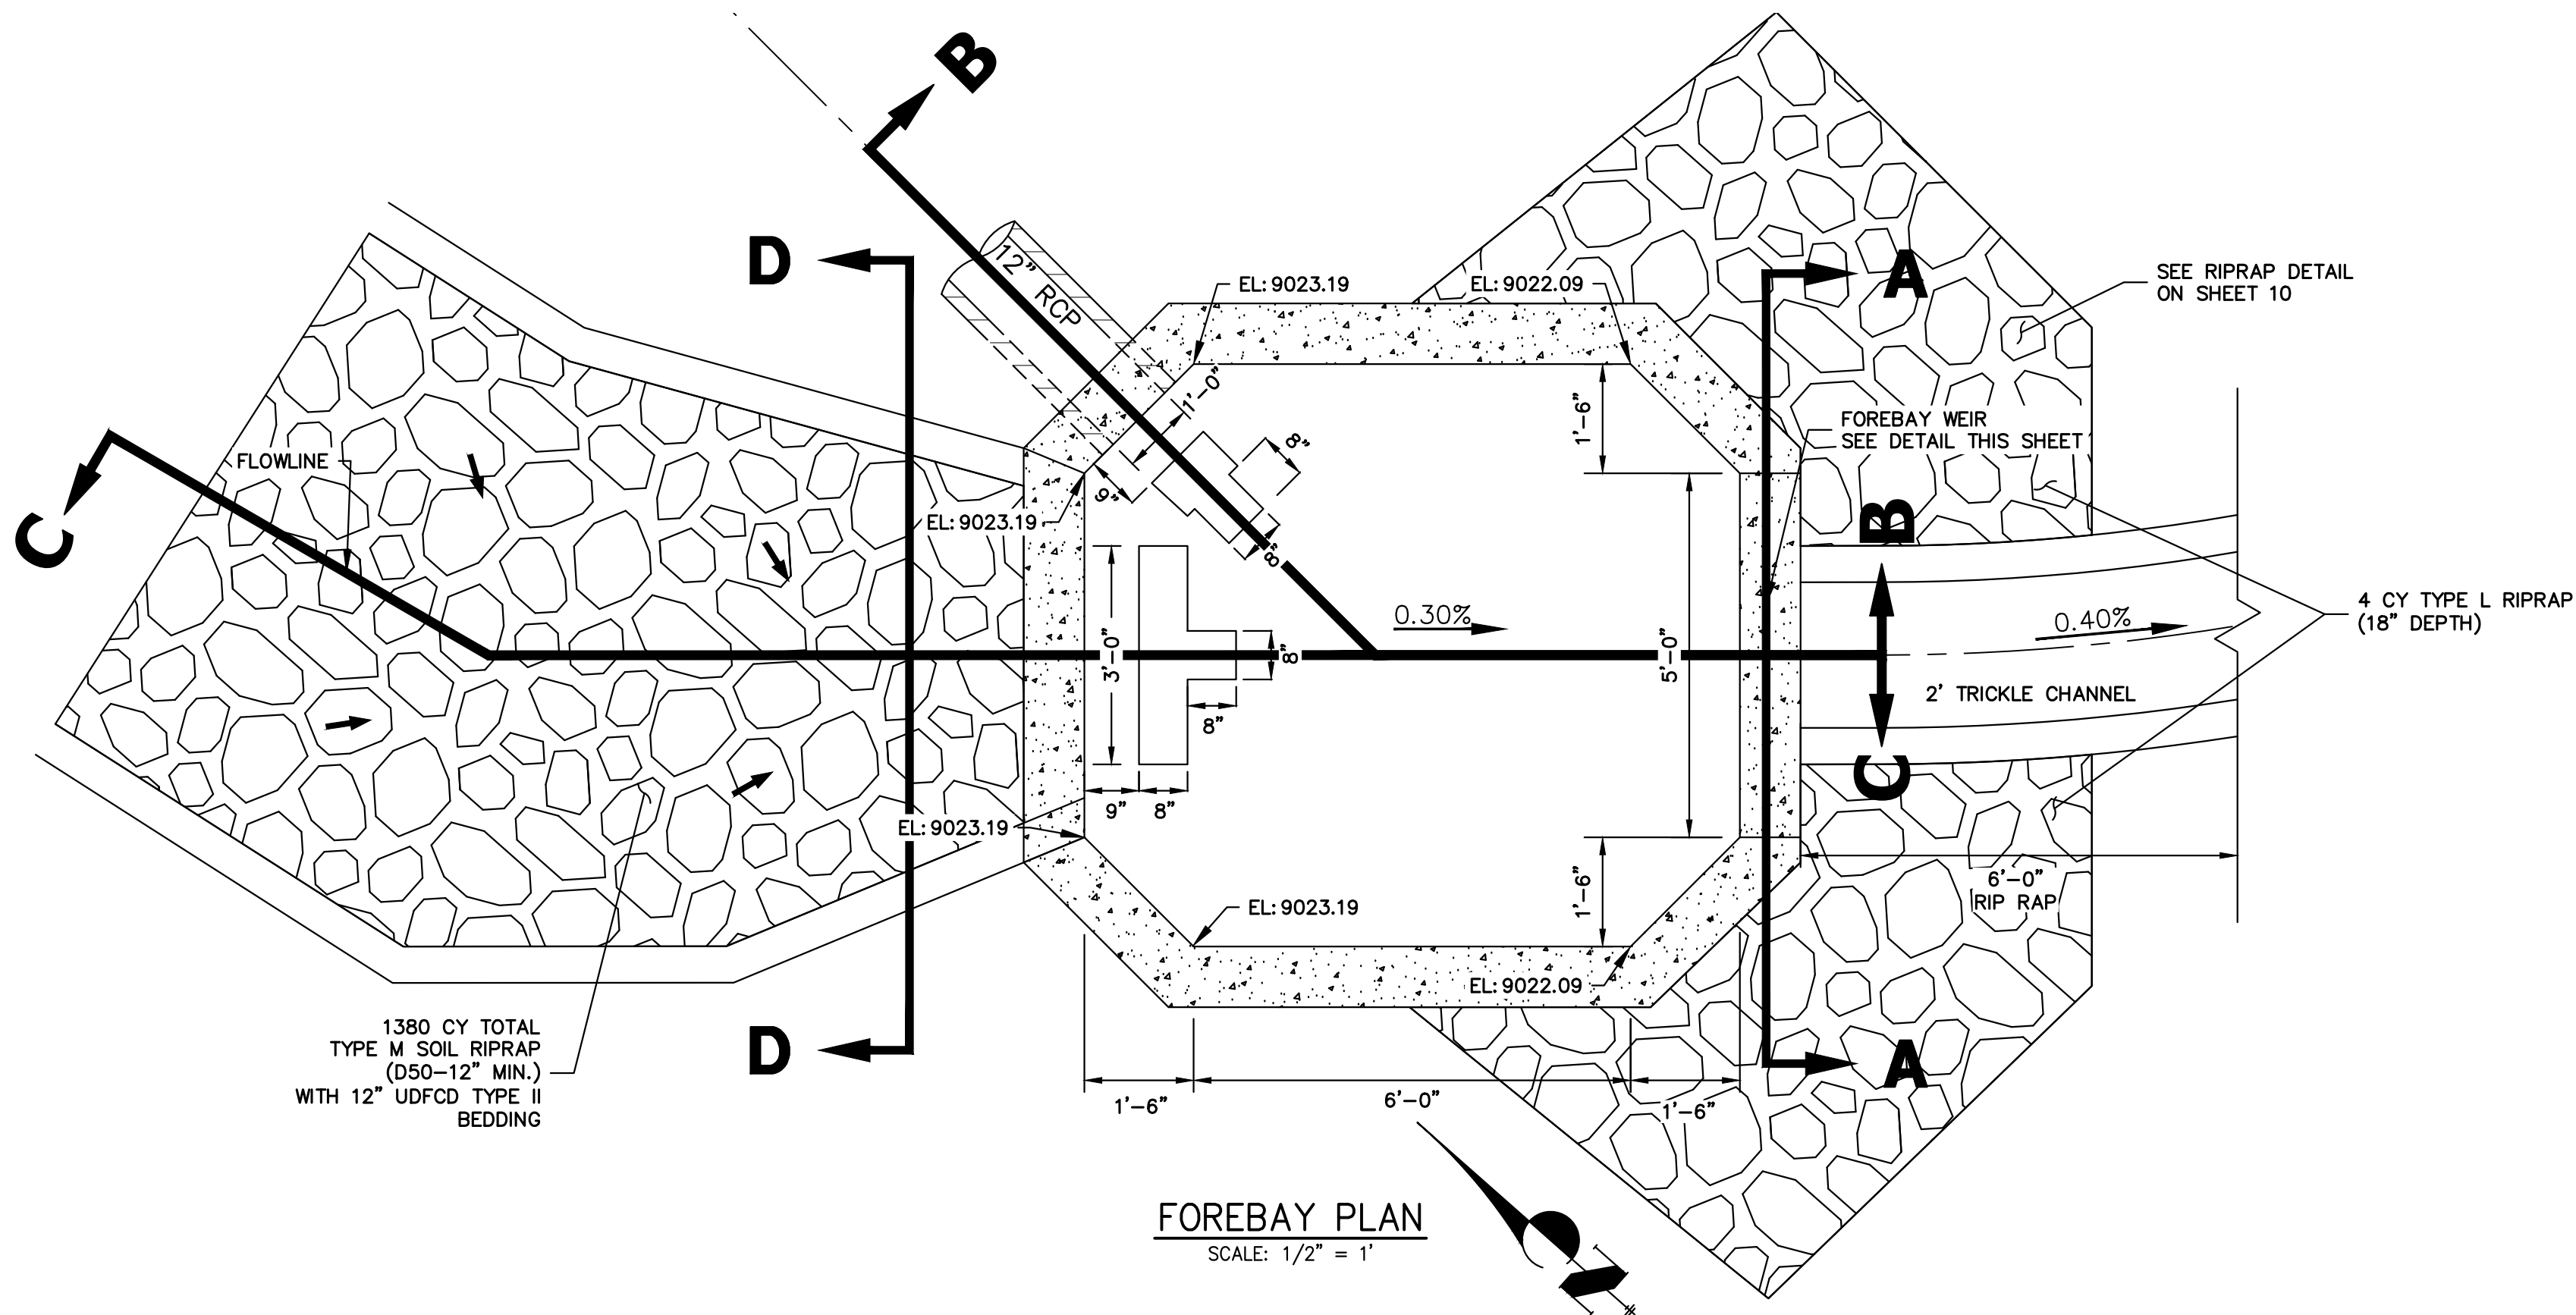

UTILITY VAULT DETAIL
INTERIOR PLAN VIEW
SCALE: 1"=1'



UTILITY VAULT DETAIL
SECTION A
SCALE: 1"=1'

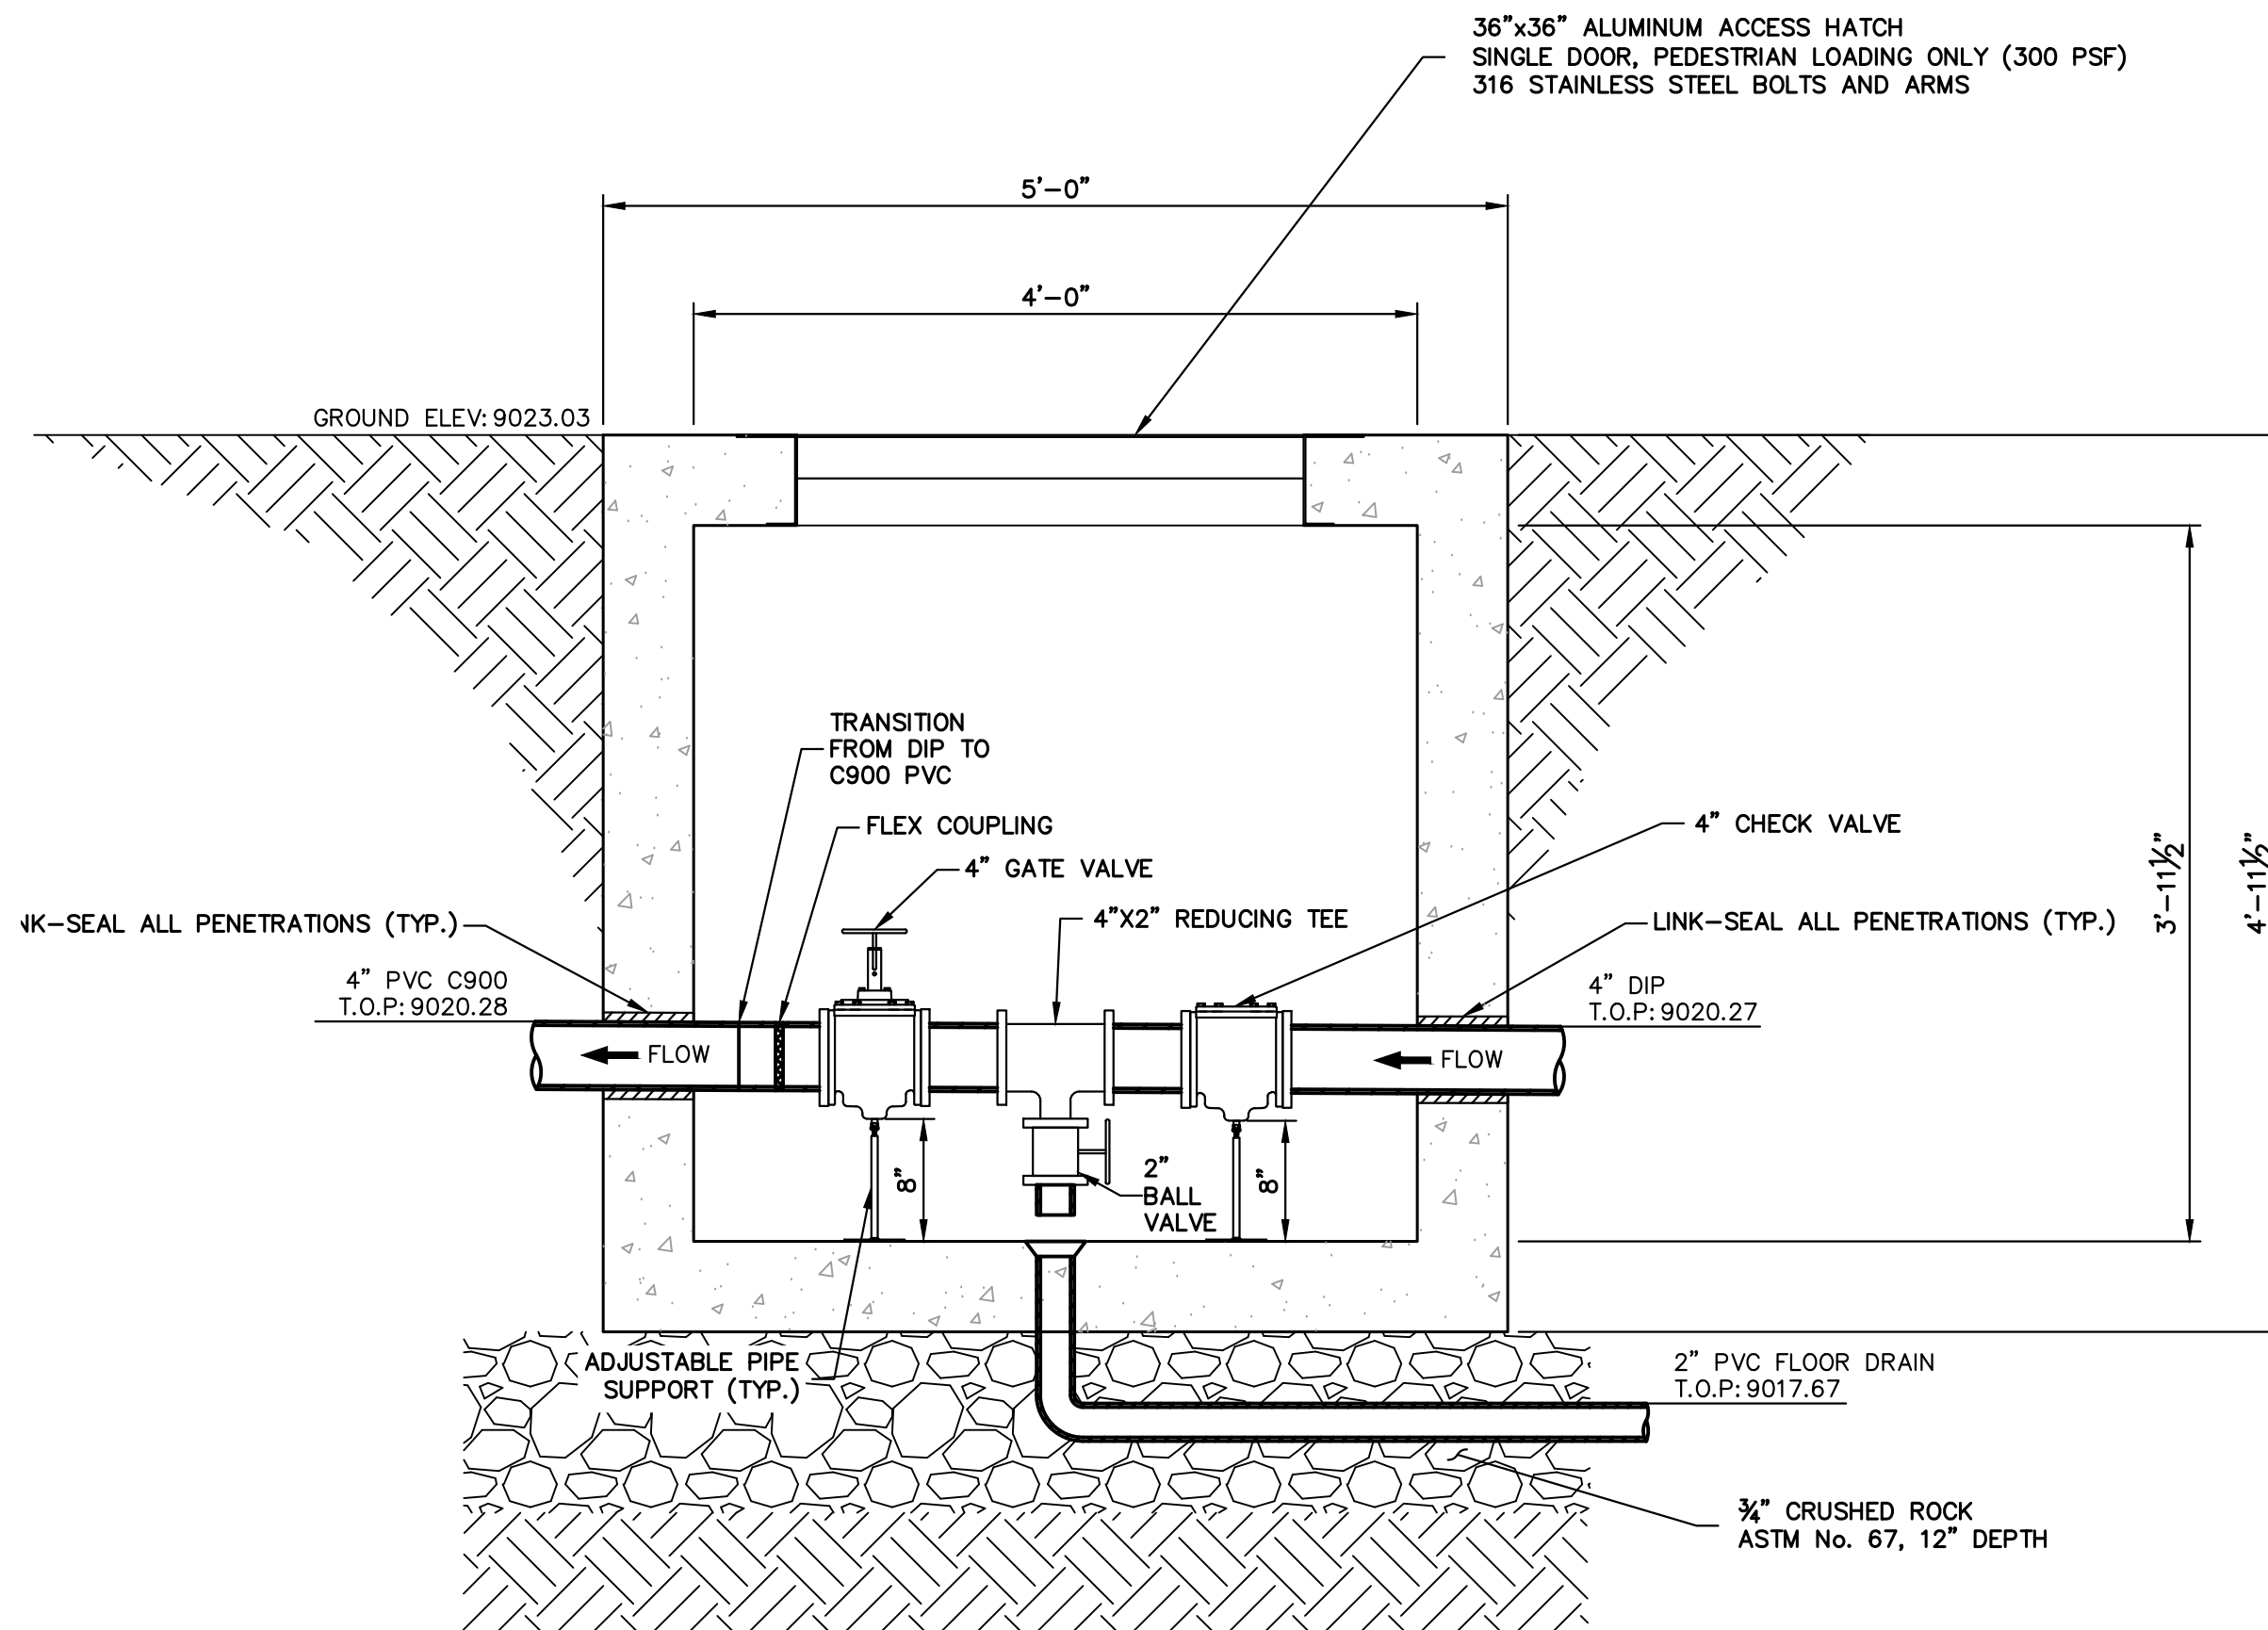

UTILITY VAULT DETAIL
SECTION B
SCALE: 1"=1'

- UTILITY VAULT NOTES:**
1. PROVIDE 10" CAST-OUT HOLES IN VAULT WALLS & ANCHOR THE PIPE TO WALLS
 2. RESTRAIN FITTING ENDS WITH MEGALUGS OR EQUAL.
 3. ALL PIPING FOR METER VAULTS SHALL BE DUCTILE IRON (DIP) & RESTRAINED.
 4. TRACER WIRE SHALL BE TERMINATED IN EACH METER VAULT BY WRAPPING THE WIRE THREE TIMES AROUND THE GATE VALVE.
 5. ALUMINUM HATCH TO BE SECURED (BOLTED & LOCKABLE) WITH DIAMOND TREAD FINISH, HALLIDAY SIR OR APPROVED EQUIVALENT
 6. ALL HOLE PENETRATIONS TO BE CAST-OUT W/ LINK-SEAL OR APPROVED EQUAL.
 7. CONTRACTOR TO SUBMIT SHOP DRAWINGS PRIOR TO ORDERING ANY ITEMS FOR CONSTRUCTION.
 8. CONTRACTOR TO COORDINATE CONNECTION TO POWER SOURCE.
 9. CHECK VALVE SHALL BE VALMATIC SURGEBUSTER OR APPROVED EQUIVALENT.



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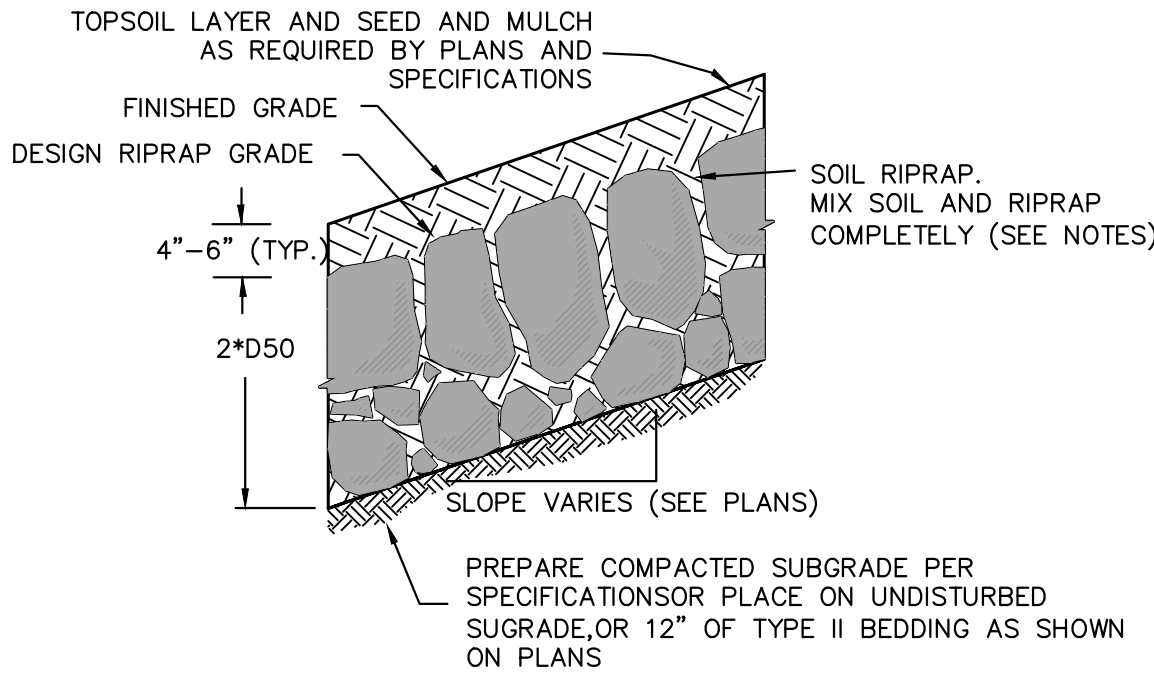
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						12/30/22	AHC		
							AHC		
FRISCO BAY MARINA STORM DRAINAGE IMPROVEMENTS									
UTILITY VAULT DETAILS									
SHEET 11 OF 15									
JOB NO. 16113.00									

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SOIL RIPRAP EMBANKMENT PROTECTION
WITH MULCH TYP. SECTION

N.T.S.

TYPE M RIPRAP

INTERMEDIATE ROCK DIMENSION (IN.)	PERCENT PASSING (%)
21	70-100
18	50-70
12	35-50
4	2-10

*TYPE M RIPRAP D₅₀=12".
D₅₀ = MEAN PARTICLE SIZE
(INTERMEDIATE DIMENSION) BY WEIGHT.



TYPE L RIPRAP

INTERMEDIATE ROCK DIMENSION (IN.)	PERCENT PASSING (%)
15	70-100
12	50-70
9	35-50
3	2-10

*TYPE L RIPRAP D₅₀=9".
D₅₀ = MEAN PARTICLE SIZE
(INTERMEDIATE DIMENSION) BY WEIGHT.

RIPRAP NOTES:

1. SOIL RIPRAP DETAILS ARE APPLICABLE TO SLOPED AREAS. REFER TO THE SITE PLAN ACTUAL LOCATION AND LIMITS.
2. MIX UNIFORMLY 65% RIPRAP BY VOLUME WITH 35% OF APPROVED SOIL BY VOLUME PRIOR TO PLACEMENT.
3. PLACE STONE-SOIL MIX TO RESULT IN SECURELY INTERLOCKED ROCK AT THE DESIGN THICKNESS AND GRADE. COMPACT AND LEVEL TO ELIMINATE ALL VOIDS AND ROCKS PROJECTING ABOVE DESIGN RIPRAP TOP GRADE.
4. CRIMP OR TACKIFY MULCH OR USE APPROVED HYDROMULCH AS CALLED FOR IN THE PLANS AND SPECIFICATIONS.
5. ROCK SHALL BE HARD, DURABLE, ANGULAR IN SHAPE, AND FREE FROM CRACKS, OVERBURDEN, SHALE, AND ORGANIC MATTER.
6. NEITHER BREADTH NOR THICKNESS OF A SINGLE STONE SHOULD BE LESS THAN ONE-THIRD ITS LENGTH, AND ROUNDED STONE SHOULD BE AVOIDED.
7. THE ROCK SHOULD SUSTAIN A LOSS OF NOT MORE THAN 40% AFTER 500 REVOLUTIONS IN AN ABRASION TEST (LOS ANGELES MACHINE ASTM C-535-69) AND SHOULD SUSTAIN A LOSS OF NOT MORE THAN 10% AFTER 12 CYCLES OF FREEZING AND THAWING (AASHTO TEST 103 FOR LEDGE ROCK PROCEDURE A).
8. ROCK HAVING A MINIMUM SPECIFIC GRAVITY OF 2.65 IS PREFERRED; HOWEVER, IN NO CASE SHOULD ROCK HAVE A SPECIFIC GRAVITY LESS THAN 2.50.

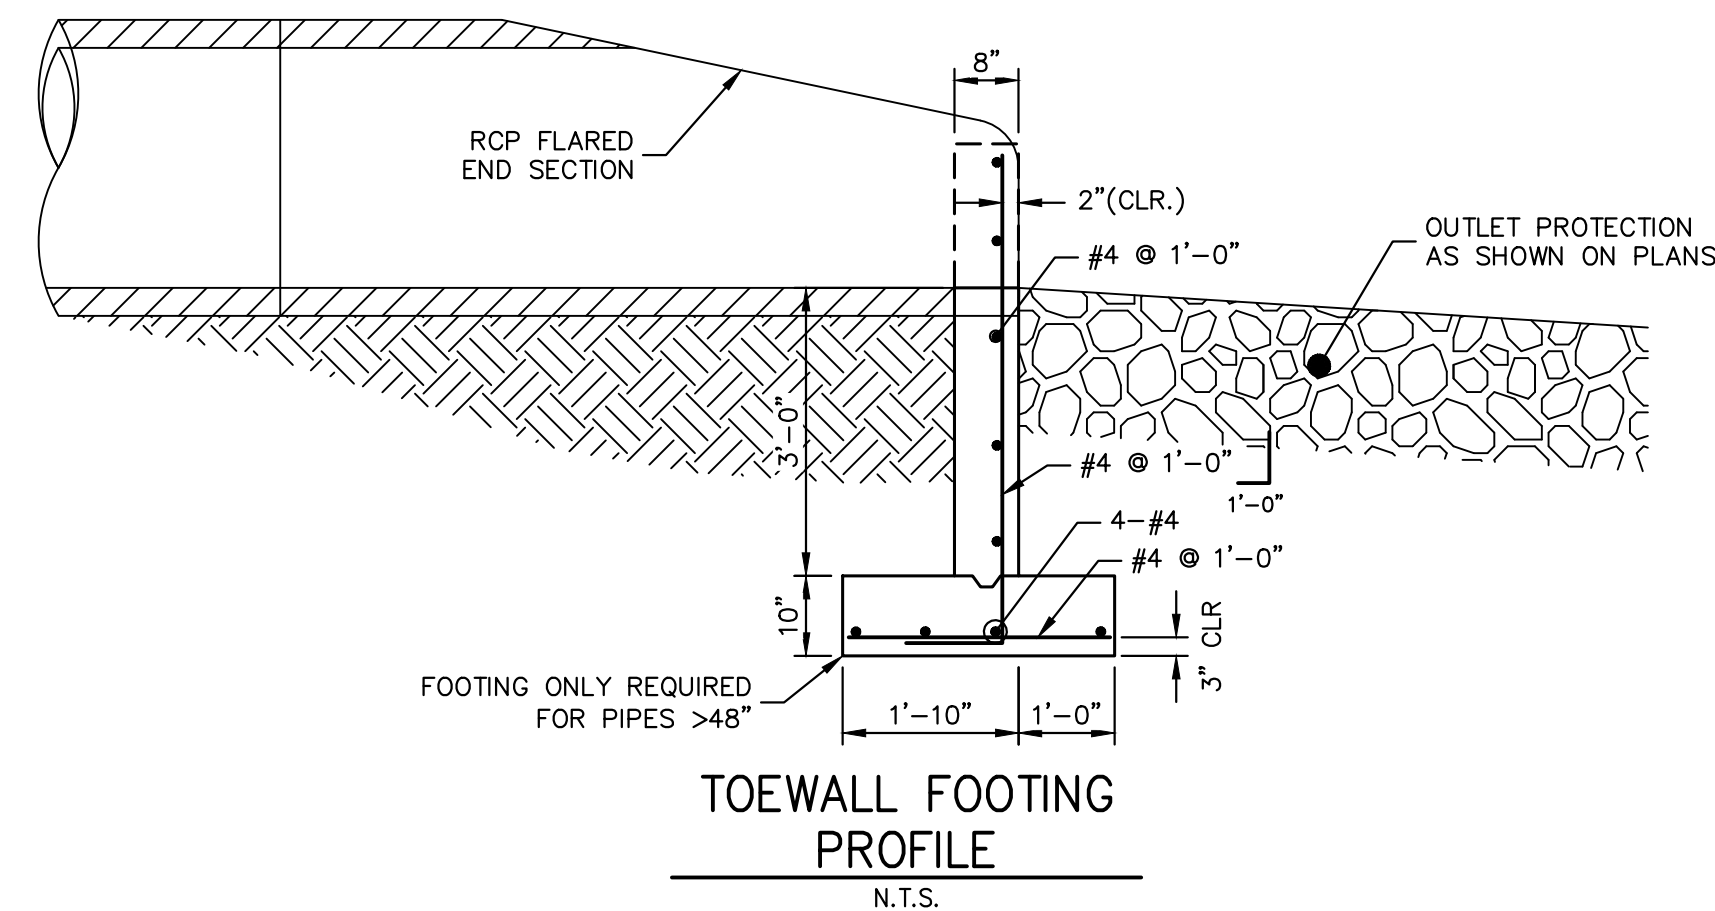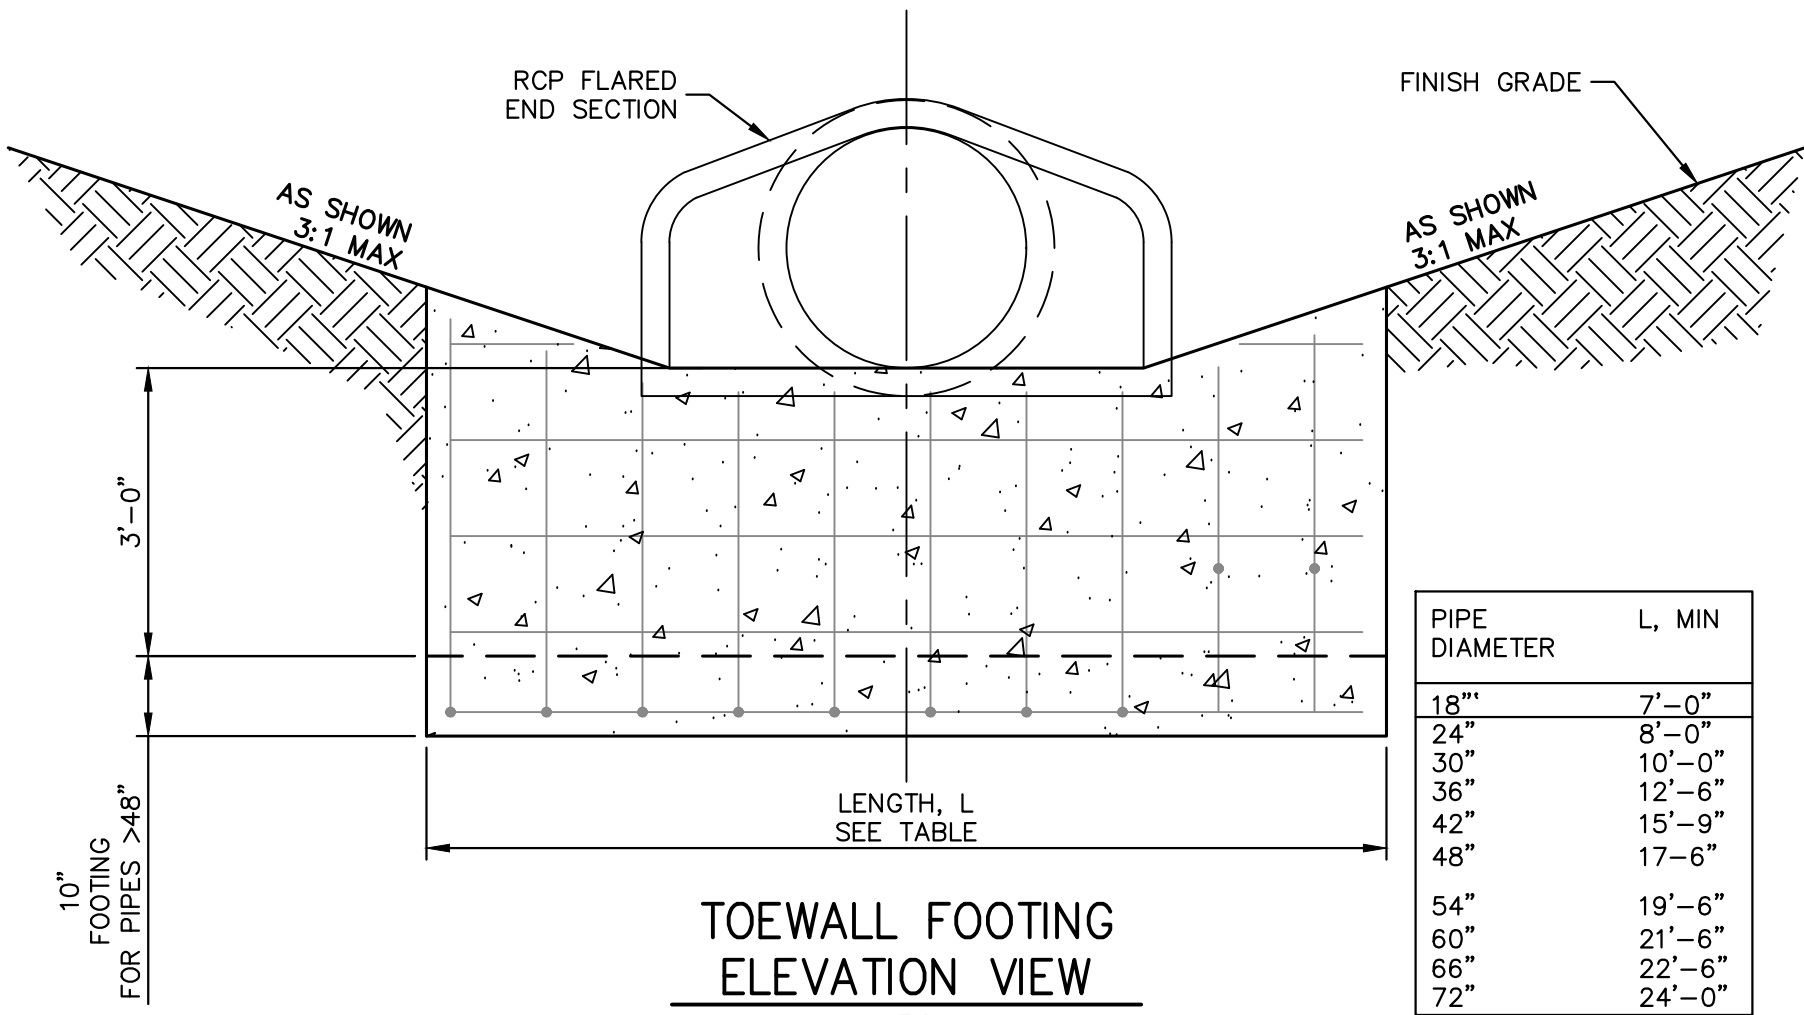


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FRISCO BAY MARINA STORM
DRAINAGE IMPROVEMENTS

STANDARD DETAILS

SHEET 12 OF 15

JOB NO. 16113.00

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V-SCALE	AS SHOWN				
DATE	12/30/22				
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J.R. ENGINEERING
A Westman Company

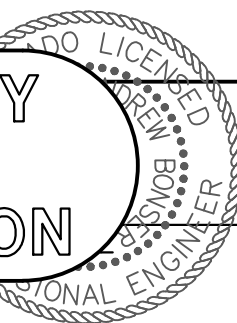
Central 303-740-9888 • Colorado Springs 719-583-2583
Fort Collins 970-491-9888 • www.jrengineering.com

No.	REVISION	BY	DATE

Town of Frisco
Frisco Bay Marina Boat Ramp Turnaround Drainage Improvements
Bid Schedule January 4, 2023

NO.	DESCRIPTION	QUANTITY	UNIT	UNIT PRICE	COST
1	Mobilization	1	LS	\$ _____	\$ _____
2	Survey	1	LS	\$ _____	\$ _____
3	Dewatering	1	LS	\$ _____	\$ _____
4	Removal of Pipe	45	LF	\$ _____	\$ _____
5	Removal of Concrete Sidewalk	4	SY	\$ _____	\$ _____
6	Removal of Asphalt (Full Depth)	77	SY	\$ _____	\$ _____
7	Removal of Manhole (Dry Well)	1	EA	\$ _____	\$ _____
8	Unclassified Excavation (CIP)	350	CY	\$ _____	\$ _____
9	Electrical Connection and Distribution	1	LS	\$ _____	\$ _____
10	2" PVC Conduit (Electrical Power Supply)	82	LF	\$ _____	\$ _____
11	Xylem Goulds Sump Pump (Install Only)	1	LS	\$ _____	\$ _____
12	Pump Rail Sytem and Appurtenances	1	LS	\$ _____	\$ _____
13	331-SV Control Panel with 2 Floats and Starter (Install Only)	1	LS	\$ _____	\$ _____
14	2" Valves and Appurtenances	2	EA	\$ _____	\$ _____
15	4" Valves and Appurtenances	7	EA	\$ _____	\$ _____
16	2" PVC C900 (Class 150)	10	LF	\$ _____	\$ _____
17	4" PVC C900 (Class 150) Force Main	170	LF	\$ _____	\$ _____
18	4" DIP Force Main	20	LF	\$ _____	\$ _____
19	12" RCP	170	LF	\$ _____	\$ _____
20	Manhole, Storm (4 Feet Dia) (5-10 Foot)	1	EA	\$ _____	\$ _____
21	Manhole, Storm (8 Feet Dia) (10-15 Foot) [Wet Well]	1	LS	\$ _____	\$ _____
22	Utility Vault (4'x4')	1	LS	\$ _____	\$ _____
23	Water Quality Pond Outlet Structure	1	LS	\$ _____	\$ _____
24	2' Trickle Channel	106	LF	\$ _____	\$ _____
25	Riprap, Type M (24") [Spillway and Forebay]	30	CY	\$ _____	\$ _____
26	Riprap, Type L (18") [Outfall]	5	CY	\$ _____	\$ _____
27	Concrete Sidewalk	4	SY	\$ _____	\$ _____
28	Forebay and Headwall Concrete	20	CY	\$ _____	\$ _____
29	Run-Down Concrete	10	CY	\$ _____	\$ _____
30	Concrete Maintenance Trail	80	SY	\$ _____	\$ _____
31	Concrete (Flow-Fill 18" and 36" Pipe)	17	CY	\$ _____	\$ _____
32	Concrete, Class B (WQ Wier Crest Wall)	1	LS	\$ _____	\$ _____
33	HMA (Grading SX)(75)(PG 58-28)	20	TN	\$ _____	\$ _____
34	Concrete Washout Structure	1	EA	\$ _____	\$ _____
35	Seeding and Mulching [Native]	0.5	AC	\$ _____	\$ _____
36	Street Sweeping	1	LS	\$ _____	\$ _____
37	Stabilized Staging Area	1	LS	\$ _____	\$ _____
38	Silt Fence	730	LF	\$ _____	\$ _____
39	Landscape Restoration	846	SF	\$ _____	\$ _____
				TOTAL BID: \$ _____	

TOTAL

BID WRITTEN

IN WORDS:

Contractor Name: _____

Address: _____

Phone: _____

1/4/2023

Bid Schedule - 1 of 1